BEDFORD, MASSACHUSETTS

RICHARD ROAD CULVERT REPLACEMENT




TOWN OF BEDFORD

ISSUED FOR BID

JUNE 2024

	SHEET INDEX		
GENERA	L		
G-000	COVER SHEET		
G-001	GENERAL NOTES, LEGEND, AND ABBREVIATIONS		
CIVIL			
C-100	EXISTING CONDITIONS SITE DEMOLITION PLAN		
C-200	CULVERT PLAN & PROFILE		
C-201	SITE RESTORATION PLAN		
C-202	CULVERT INLET AND OUTLET PLANS		
C-300	CIVIL DETAILS - 1		
C-301	CIVIL DETAILS - 2		
C-302	CIVIL DETAILS - 3		
C-303	CIVIL DETAILS - 4		
C-304	CIVIL DETAILS - 5		

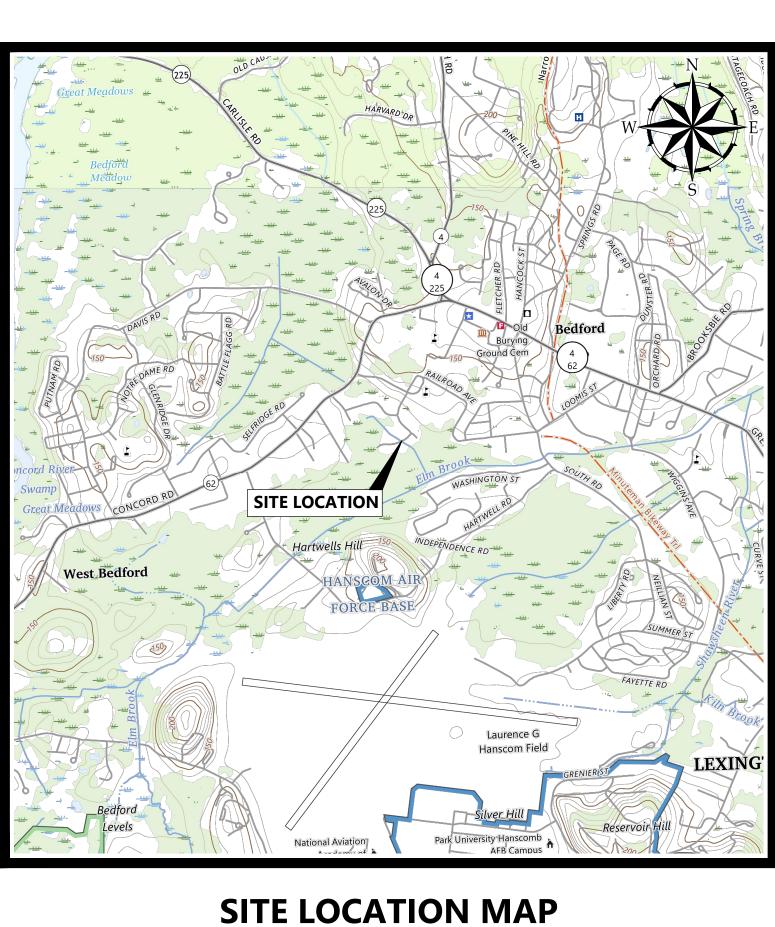

SOURCE: USGS TOPO QUADRANGLE

& 40 Sha Andove	Codard Curran attuck Road, Suite 110 er, Massachusetts 01810 1 www.woodardcurran.com
WOODARD REPRODUCTIO	UMENT IS THE PROPERTY OF & CURRAN AND ITS CLIENT. N OR MODIFICATION WITHOUT PERMISSION IS PROHIBITED.
PE SEAL:	www.
COMMON COMMON	SCOTT C. SALVUCCI CIVIL No. 52343 CONAL ENSING
ISS	SUED FOR BID
CLIENT INFO:	
-	N OF BEDFORD D, MASSACHUSETTS
	CHARD ROAD RT REPLACEMENT
REV MM/DD/YY	DESCRIPTION
JOB NO: DATE:	0235172.01 JUNE 2024
SCALE: DESIGNED BY:	NONE KLR
DRAWN BY:	JBC GB
FILENAME:	0235172.01 G000.dwg
DRAWING TITLE:	GENERAL OVER SHEET
DRAWING NO:	G-000

GENERAL NOTES

- 1. EXISTING CONDITIONS ARE BASED ON A SURVEY PERFORMED BY CHAPPEL ENGINEERING ASSOCIATES. TOPOGRAPHIC DRAWING FILES DATED DECEMBER 2023.
- 2. WETLAND DELINEATION WAS PREPARED BY ECOTEC, INC. THE WETLAND RESOURCE EVALUATION REPORTS ARE DATED NOVEMBER 1, 2023 AND WETLAND FIELD INSPECTION WAS CONDUCTED ON OCTOBER 24, 2023.
- 3. THE HORIZONTAL AND VERTICAL DATUM DEPICTED ON THE MAPS HEREON IS BASED ON THE MASSACHUSETTS STATE PLANE COORDINATE SYSTEM, MAINLAND ZONE, REFERENCED TO THE NORTH AMERICAN DATUM OF 1983 (NAD 83).
- 4. ANY PROPERTY AND RIGHT OF WAY LOCATIONS THAT MAY BE SHOWN HEREON ARE APPROXIMATE AND DO NOT REPRESENT A PROPERTY BOUNDARY SURVEY.
- 5. WOODARD & CURRAN ASSUMES NO RESPONSIBILITY FOR DAMAGES INCURRED AS A RESULT OF UTILITIES OMITTED OR INACCURATELY SHOWN.
- 6. COORDINATE CONSTRUCTION ACTIVITY WITH UTILITY COMPANIES, EMERGENCY SERVICES AND TOWN. CONTRACTOR SHALL NOTIFY ALL UTILITIES PRIOR TO COMMENCING WORK, ALLOWING SUFFICIENT TIME TO LOCATE AND MARK THE LOCATION OF BURIED UTILITIES. CONTRACTOR SHALL CONTACT "DIG SAFE", TELEPHONE 811, PRIOR TO EXCAVATION.
- 7. RESTORE ALL AREAS DISTURBED BY CONTRACTOR'S OPERATIONS TO ORIGINAL FINISH (GRAVEL, PAVEMENT, GRASS, ETC.) UNLESS NOTED OTHERWISE ON THE PLANS. RESTORATION OF PAVED SURFACES, GRAVEL SURFACES, DRIVEWAYS, AND LAWNS DAMAGED BY CONSTRUCTION ACTIVITIES SHALL BE PERFORMED AT NO ADDITIONAL COST TO OWNER. ANY CURB DAMAGED BY CONSTRUCTION ACTIVITIES SHALL BE REPLACED IN KIND AND SHALL CONFORM TO TOWN OF BEDFORD AND MASSACHUSETTS DOT SPECIFICATIONS AT NO ADDITIONAL COST TO OWNER.
- 8. PROPERLY PROTECT AND DO NOT DISTURB PROPERTY IRONS AND MONUMENTS. IF DISTURBED, THE PROPERTY MONUMENT SHALL BE RESET AT THE CONTRACTOR'S EXPENSE BY A LICENSED LAND SURVEYOR ACCEPTABLE TO THE TOWN.
- 9. EXISTING FACILITIES (I.E. TREES, POLES, LIGHT POSTS, CATCH BASINS, STONE FROM CULVERT, ETC.) SHALL BE REMOVED AND PROTECTED DURING CONSTRUCTION. THE TOWN RETAINS RIGHT TO KEEP ANY AND ALL REMOVED FACILITIES. CONTRACTOR SHALL DISPOSE OF ANY REMOVED FACILITY AT THE REQUEST OF THE TOWN AT NO ADDITIONAL COST TO OWNER.
- 10. ALL TREES NOT NOTED TO BE REMOVED OR RELOCATED SHALL BE PROTECTED BY CONTRACTOR DURING CONSTRUCTION.
- 11. DO NOT PARK, IMPEDE ACCESS TO, OR STORE EQUIPMENT BEYOND LIMIT OF WORK, UNLESS PERMISSION HAS BEEN GRANTED IN WRITING BY TOWN AND/OR LAND OWNER.
- 12. RESTRICT ACCESS TO SITE THROUGH THE USE OF APPROPRIATE SIGNAGE, BARRIERS, FENCES, ETC. SITE SHALL BE LEFT WITH APPROPRIATE SAFETY MEASURES IN PLACE DURING NON-WORKING HOURS. SITE SAFETY IS THE RESPONSIBILITY OF CONTRACTOR, DURING BOTH WORKING AND NON-WORKING HOURS.
- 13. CONTRACTOR IS RESPONSIBLE FOR OBTAINING ALL NECESSARY CONSTRUCTION PERMITS INCLUDING "PERMIT TO OPEN OR OCCUPY STREET/ SIDEWALK" FROM THE TOWN. PERMIT APPLICATIONS SHALL BE SUBMITTED WITH ADEQUATE TIME SO AS NOT TO DELAY CONSTRUCTION.
- 14. ALL WORK ASSOCIATED WITH THE PROJECT SHALL BE COMPLETED IN ACCORDANCE WITH THE TOWN OF BEDFORD BYLAW AND LOCAL REGULATIONS AND MASSACHUSETTS DOT STANDARD SPECIFICATIONS.
- 15. UPON COMPLETION OF CONSTRUCTION, A COMPLETE SET OF "RECORD" DRAWINGS SHALL BE SUBMITTED TO THE TOWN ENGINEER. THESE DRAWINGS SHALL BE SUBMITTED IN BOTH DIGITAL AND HARD COPY FORMAT AS DEFINED IN THE SPECIFICATIONS PRIOR TO PAYMENT OF FINAL RETAINAGE.
- 16. PROTECTION OF EXISTING UTILITIES DURING CONSTRUCTION SHALL BE PROVIDED AT NO ADDITIONAL COST.
- 17. CONTRACTOR SHALL BE RESPONSIBLE FOR SWEEPING RICHARD ROAD EVERY FRIDAY AND AS

NECESSARY DURING THE DURATION OF THE WORK.

- 18. AT LEAST 24 HOURS PRIOR TO THE START OF CONSTRUCTION, CONTRACTOR SHALL ATTEND A PRE-CONSTRUCTION MEETING HELD AT THE PROJECT SITE WITH THE CONTRACTOR, ENGINEER, OWNER, AND CONSERVATION OFFICE TO REVIEW THE CONSTRUCTION SCHEDULE AND SEQUENCING, ORDER OF CONDITIONS, STOCKPILE LOCATIONS AND CRITICAL ASPECTS OF THE PROJECT.
- 19. PRIOR TO THE START OF WORK, CONTRACTOR SHALL CONFIRM EXISTING WETLAND FLAGS ARE IN PLACE AND SHALL BE MAINTAINED DURING CONSTRUCTION. MISSING FLAGS SHALL BE RESET PRIOR TO CONSTRUCTION. AN AUTOCAD FILE OF THE WETLAND FLAG LOCATIONS SHALL BE PROVIDED FOR CONTRACTOR'S USE IN RESETTING WETLAND FLAGS.
- 20. NO EQUIPMENT IS TO CROSS OR ENTER WETLAND RESOURCE AREAS AT ANY TIME UNLESS THE LOCATION OF DISTURBANCE IS MARKED ON THE PLANS REFERENCE IN THE ORDER OF CONDITIONS AND FLAGGED IN THE FIELD.
- 21. ALL DISTURBED UPLAND AREAS SHALL BE BROUGHT TO FINAL GRADE AND SHALL BE PERMANENTLY STABILIZED WITHIN 30 DAYS AFTER DISTURBANCE. BARE GROUND AND DISTURBED AREAS THAT CANNOT BE PERMANENTLY VEGETATED WITHIN 30 DAYS SHALL BE TEMPORARY STABILIZED BY AN APPROVED METHOD.
- 22. PRIOR TO PLANTING OR SEEDING RESTORATION AREA, A LICENSED SURVEYOR SHALL SURVEY FINAL GRADES TO ENSURE GRADES HAVE BEEN ACHIEVED AS SHOWN ON PLANS.
- 23. CONTRACTOR SHALL DEMARCATE CONSTRUCTION EQUIPMENT AND MATERIAL STORAGE AREAS PRIOR TO CONSTRUCTION.
- 24. THE CONSTRUCTION SITE SHALL BE MAINTAINED IN CLEAN CONDITIONS AT ALL TIMES AND CONSTRUCTION REFUSE AND DEBRIS SHALL BE DISPOSED OF PROMPTLY AND IN A LEGAL MANNER.
- 25. STORING, SERVICING, OR CLEANING OF TRUCKS OR EQUIPMENT SHALL BE PERFORMED IN AN UPLAND AREA AT A HORIZONTAL DISTANCE GREATER THAN 100 FEET FROM THE WETLAND RESOURCE AREAS. ALL FUELING SHALL TAKE PLACE ON HARD/PAVED SURFACES AND OUTSIDE THE 100-FOOT BORDERING VEGETATED WETLAND BUFFER. THE CONTRACTOR SHALL MAINTAIN A MINIMUM OF 2 SPILL KITS ON SITE AND HAVE A SPILL KIT WITHIN REACH DURING REFUELING OPERATIONS.
- 26. THE CONTRACTOR, SITE ENGINEER, OR OTHER INDIVIDUAL IN CHARGE OF WORK ON THE SITE SHALL HAVE A COPY OF THE ORDER OF CONDITIONS AT ALL TIMES.
- 27. CLEANING OF TREES 3" OR GREATER IS PROHIBITED FROM JUNE 1 THROUGH JULY 31.
- 28. THE CONTRACTOR, SITE ENGINEER, OR OTHER INDIVIDUAL IN CHARGE OF WORK ON THE SITE SHALL HAVE A COPY OF THE ORDER CONDITIONS AT ALL TIME. DEP FILE #103-0925
- 29. CONTRACTOR SHALL PROVIDE A SIGN TO BE DISPLAYED AT THE SITE THAT BEARS THE FOLLOWING: "MASSACHUSETTS DEPARTMENT OF ENVIRONMENTAL PROTECTION FILE NUMBER: 103-0925". CONTRACTOR SHALL POST A COPY OF THE PLANS AND SPECIFICATIONS WITHIN A WEATHER TIGHT STORAGE DEVISE TO THE SIGN. DO NOT AFFIX SIGN TO A LIVING TREE. THE SIGN SHALL REMAIN VISIBLE UNTIL THE CONSERVATION COMMISSION ISSUES A CERTIFICATE OF COMPLIANCE.

EROSION CONTROL NOTES

- 1. EROSION CONTROL DEVICES SHALL REMAIN IN PLACE, UNTIL ALL DISTURBED SURFACES HAVE BEEN STABILIZED WITH FINAL VEGETATION COVER OR THE COMMISSION HAS AUTHORIZED THEIR REMOVAL.
- 2. EROSION CONTROL MEASURES AND BARRIERS SHALL BE MONITORED DAILY AND MAINTAINED, OR REINFORCED AS NECESSARY TO ENSURE AND PREVENT EROSION AND SILTATION OF SOILS TO WETLAND RESOURCE AREAS. ADDITIONAL FILTER FABRIC AND STRAW WATTLES SHALL BE STORED ON SITE FOR EMERGENCY USE.
- 3. DURING ALL PHASES OF CONSTRUCTION, ALL DISTURBED OR EXPOSED AREAS OUTSIDE THE ROADWAY SHALL BE BROUGHT TO FINISHED GRADE AND EITHER A) LOAMED AND SEEDED FOR PERMANENT STABILIZATION, IN ACCORDANCE WITH U.S. SOIL CONSERVATION SERVICE PROCEDURES, OR B) STABILIZED IN ANOTHER WAY APPROVED BY THE COMMISSION. AREAS THAT CANNOT BE PERMANENTLY STABILIZED WITHIN 30 DAYS OF DISTURBANCE SHALL BE STABILIZED WITH HAY, STRAW, MULCH OR ANY OTHER PROTECTIVE COVERING AND/OR METHOD APPROVED BY THE U.S. DEPARTMENT OF AGRICULTURE SOIL CONSERVATION SERVICE OR BY OTHER TEMPORARY MEASURES ACCEPTABLE TO THE COMMISSION.
- 4. PROJECT IS SUBJECT TO THE CONDITIONS SET FORTH IN PERMITS ISSUED BY THE US ARMY CORPS OF ENGINEERS, BEDFORD CONSERVATION COMMISSION, AND MASSACHUSETTS DEPARTMENT OF ENVIRONMENTAL PROTECTION, SPECIFICALLY RELATED TO LIMITS OF IMPACT, EROSION CONTROL MEASURES, RESTORATION ACTIVITIES, AND TIMEFRAME RESTRICTIONS. CONTRACTOR SHALL READ PERMIT DOCUMENTS FULLY AND CARRY OUT WORK IN ACCORDANCE WITH PERMIT DOCUMENTS. COPIES OF PERMIT DOCUMENTS ARE APPENDED TO THE PROJECT SPECIFICATIONS.
- 5. AN ADEQUATE STOCKPILE OF EROSION AND SEDIMENTATION CONTROL MATERIALS SHALL BE ON SITE AT ALL TIMES FOR EMERGENCY OR ROUTINE REPLACEMENT.
- 6. ANY DAMAGE CAUSED AS A DIRECT RESULT OF CONSTRUCTION TO THE WETLAND RESOURCE AREAS SHALL BE REPAIRED, RESTORED AND/OR REPLACED. SEDIMENTATION OR EROSION SHALL BE CONSIDERED DAMAGE TO THE WETLAND RESOURCE AREAS. IF SEDIMENTATION REACHES THESE AREAS, THE CONSERVATION COMMISSION SHALL BE CONTACTED AND A PLAN FOR THE PROPOSED RESTORATION SHALL BE SUBMITTED FOR APPROVAL.
- 7. THE SILT FENCE AND STRAW BALES MUST BE INSPECTED PRIOR TO THE START OF ANY WORK DAY OR A \$100 PER DAY FINE WILL BE LEVIED ON THE CONTRACTOR.

DEWATERING NOTES

- 1. AT LEAST 1 WEEK PRIOR TO THE PRECONSTRUCTION CONFERENCE THE CONTRACTOR SHALL PROVIDE THE CONSERVATION OFFICE WITH A DEWATERING & BYPASS PLAN SPECIFIC TO EACH SITE. EACH DEWATERING PLAN MUST INCLUDE DETAILS AND SPECIFICATION ON THE PROPOSED COFFER DAM TO BE EMPLOYED. THE PLAN SHALL BE APPROVED BY THE OWNER AND ENGINEER PRIOR TO IMPLEMENTATION.
- 2. ALL DEWATERING ACTIVITIES SHALL MEET LOCAL, STATE, AND FEDERAL REGULATIONS.
- 3. THE CONTRACTOR IS RESPONSIBLE FOR ALL LABOR AND EQUIPMENT REQUIRED TO PERFORM THE WORK INCLUDING BUT NOT LIMITED TO PROPER SHORING, DEWATERING EQUIPMENT, AND WATER TREATMENT EQUIPMENT IN ACCORDANCE WITH THE SPECIFICATIONS AND ALL
- 4. ALL DREDGING OPERATIONS SHALL BE CONDUCTED FROM UPLAND AREAS.
- 5. ALL DREDGE SPOILS SHALL BE DEWATERED AND DISPOSED OF AT AN UPLAND LOCATION (OR OTHER APPROVED LOCATION).
- 6. THE REMOVAL OF MATERIAL FROM THE STREAM BOTTOM SHALL BE DONE IN SUCH A MANNER AS TO ENSURE THAT THE RECONFIGURED BOTTOM AREA WILL NOT IMPEDE OR OBSTRUCT FISH MIGRATION, OR INTERFERE WITH THE NATURAL FLOW OF THE BROOK.
- 7. DEWATERING ACTIVITIES SHALL BE CONDUCTED AS SHOWN ON THE APPROVED PLANS AND SHALL BE MONITORED DAILY TO ENSURE THAT SEDIMENT LADEN WATER IS APPROPRIATELY SETTLED PRIOR TO DISCHARGE TOWARD THE RESOURCE AREAS. NO DISCHARGE OF WATER IS ALLOWED DIRECTLY INTO AN AREA SUBJECT TO JURISDICTION OF THE WETLANDS PROTECTION ACT, IF EMERGENCY DEWATERING REQUIREMENTS ARISE, THE APPLICANT SHALL SUBMIT A CONTINGENCY PLAN TO THE COMMISSION FOR APPROVAL WHICH PROVIDES FOR THE PUMPED WATER TO BE CONTAINED IN A SETTLING BASIN, TO REDUCE TURBIDITY TO DISCHARGE INTO A RESOURCE AREA.

TEMPORARY DETOUR NOTES

LOCAL, STATE, AND FEDERAL REGULATIONS.

- 1. CONTRACTOR SHALL BE RESPONSIBLE FOR PROVIDING AND MAINTAINING DETOUR SIGNAGE THROUGHOUT THE DURATION OF CONSTRUCTION.
- 2. ALL CONSTRUCTION SIGNAGE SHALL BE IN ACCORDANCE WITH MANUAL ON UNIFORM TRAFFIC CONTROL DEVICES FOR STREETS AND HIGHWAYS.

LINE TYPES LEGEND

DESCRIPTION	EXISTING	PROPOSED
CONTOUR (1' INTERVAL)		
CONTOUR (INDEX)	200	200
STORM DRAIN	SD	SD
EDGE OF PAVEMENT		
GAS LINE	G	
SEWER MAIN	S	S
WATER LINE	W	
OVERHEAD ELECTRIC	OE	
RIGHT OF WAY/ PROPERTY LINE		
LIMIT OF WORK		LW
COFFERDAM		CD
SEDIMENT BARRIER/SILTSOXX/ SILT	EENCE	
	FENCE	- • •
TURBIDITY CURTAIN		
SAWCUT		
TREE LINE		
BITUMINOUS PAVEMENT		
TEMPORARY GRADING EASEMENT		
RIPRAP SLOPE STABILIZATION		
DEMOLISH BIT. PAVEMENT		
CLEAR AND GRUB		
RESOURCE AREA LEGE		


EXISTING PROPOSED DESCRIPTION DRAIN MANHOLE (\mathbb{S}) SEWER MANHOLE 0^{CO} CLEANOUT PIPE CAP HYDRANT CATCH BASIN WETLAND FLAG LOCATION WF#RA-10 DRAIN MANHOLE SEWER MANHOLE WATER GATE GAS GATE UTILITY POLE $-\bigcirc$ LIGHT POLE BENCHMARK TREE **CB INLET PROTECTION** MAIL BOX • MB□


SYMBOLS LEGEND


TEST PIT

BORDERING LAND SUBJECT TO FLOODING (100-YEAR FLOOD ZONE, NO BASE FLOOD ELEVATION, DEFINED BY FEMA) BORDERING VEGETATED WETLAND ORDINARY HIGH WATER MARK (OHWM) / BANK/ MEAN ANNUAL HIGH WATER (MAHW)

ABBREVIA	ATIONS	
& A.G.	AND ABOVE GROUND	
BIT B/W BVW	BITUMINOUS BETWEEN BORDERING VEGETATED WETLAND	Woodard
CB CI CMP CONC	CATCH BASIN CAST IRON CORRUGATED METAL PIPE CONCRETE	& Curran 40 Shattuck Road, Suite 110 Andover, Massachusetts 01810 866.702.6371 www.woodardcurran.com
D DI DIA. DMH DOT DTL.	STORM DRAIN DUCTILE IRON DIAMETER DRAIN MANHOLE DEPARTMENT OF TRANSPORTATION DETAIL	THIS DOCUMENT IS THE PROPERTY OF WOODARD & CURRAN AND ITS CLIENT. REPRODUCTION OR MODIFICATION WITHOUT WRITTEN PERMISSION IS PROHIBITED.
E EL. E.O.P. EXIST.	UNDERGROUND ELECTRICAL ELEVATION EDGE OF PAVEMENT EXISTING	
FF FT	FINISH FLOOR FOOT/FEET	
G GS GALV. GRAN.	GAS MAIN GAS SERVICE GALVANIZED GRANITE	
HDPE HDPP HYD	HIGH DENSITY POLYETHYLENE HIGH DENSITY POLYPROPYLENE HYDRANT	
INV.		
LF MASSDEP MADOT MAX. MB MIN.	LINEAR FEET MASSACHUSETTS DEPARTMENT OF ENVIRONMENTAL PROTECTION MASSACHUSETTS DEPARTMENT OF TRANSPORTATION MAXIMUM MAILBOX MINIMUM	PE SEAL:
MON N.I.C. NO.	MONUMENT NOT IN CONTRACT NUMBER	SCOTT C. SALVUCCI CIVIL
NR N.T.S. OF	NO REFUSAL NOT TO SCALE	NO. 52343
OE OH ±	OVERHEAD ELECTRIC OVERHEAD PLUS OR MINUS	TANK CONTACT ENGINEERIN
± LLS PROP. PT. PVC	PLUS OR MINUS LICENSED LAND SURVEYOR PROPOSED POINT POLYVINYL CHLORIDE	Scott Sall
R.O.W. RCP	RIGHT-OF-WAY REINFORCED CONCRETE PIPE	
REINF. REQ'D RPP	REINFORCED REQUIRED RIBBED PLASTIC PIPE	
S S	SLOPE (FT./FT.) SEWER	ISSUED FOR BID
SMH SCH STA.	SEWER MANHOLE SCHEDULE STATION	CLIENT INFO:
TYP.	TYPICAL	TOWN OF BEDFORD BEDFORD, MASSACHUSETTS
UNO UP	UNLESS NOTED OTHERWISE UTILITY POLE	RICHARD ROAD
VC VIT.	VITRIFIED CLAY VITRIFIED CLAY	CULVERT REPLACEMENT
W W W/	WEST WATER WITH	
W WS WV	WATERMAIN WATER SERVICE WATER VALVE	
		REV MM/DD/YY DESCRIPTION
		JOB NO: 0235172.01 DATE: JUNE 2024
		SCALE: AS NOTED DESIGNED BY: KLR
		DRAWN BY: JBC CHECKED BY: GB
		FILENAME: 0235172.01 G001.dwg DRAWING TITLE:
		GENERAL GENERAL NOTES, LEGEND, AND ABBREVIATIONS
		DRAWING NO:

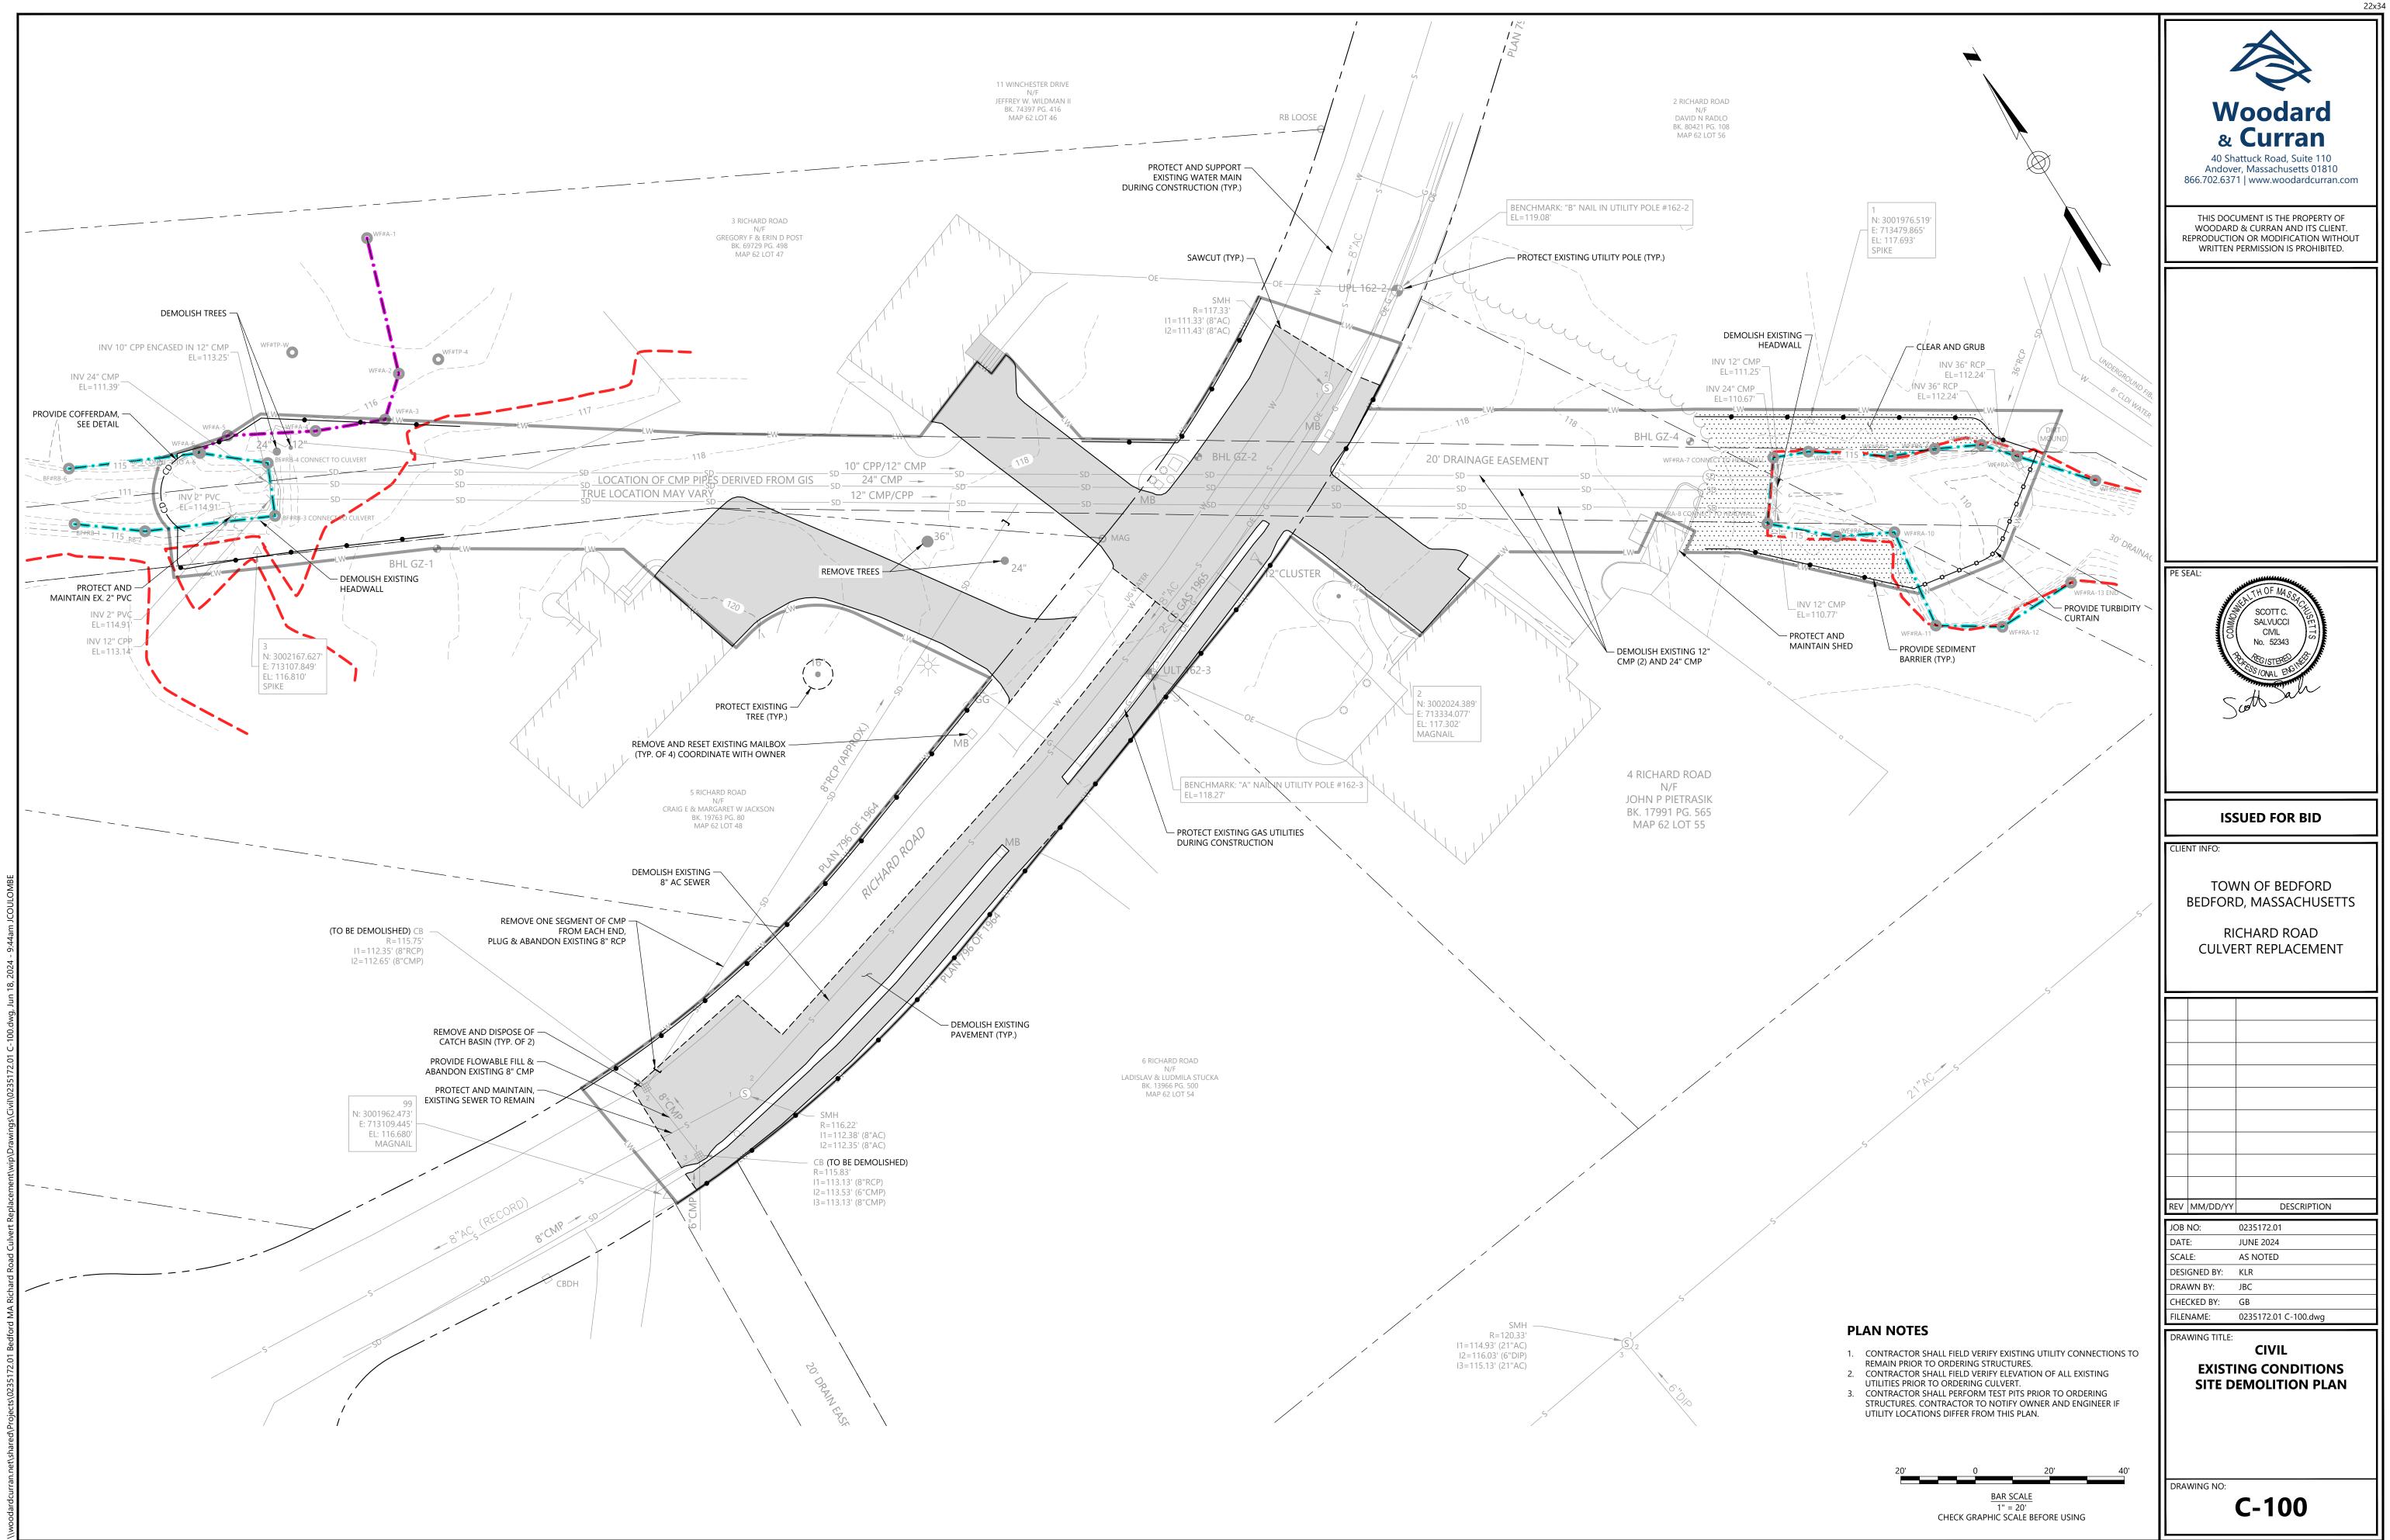


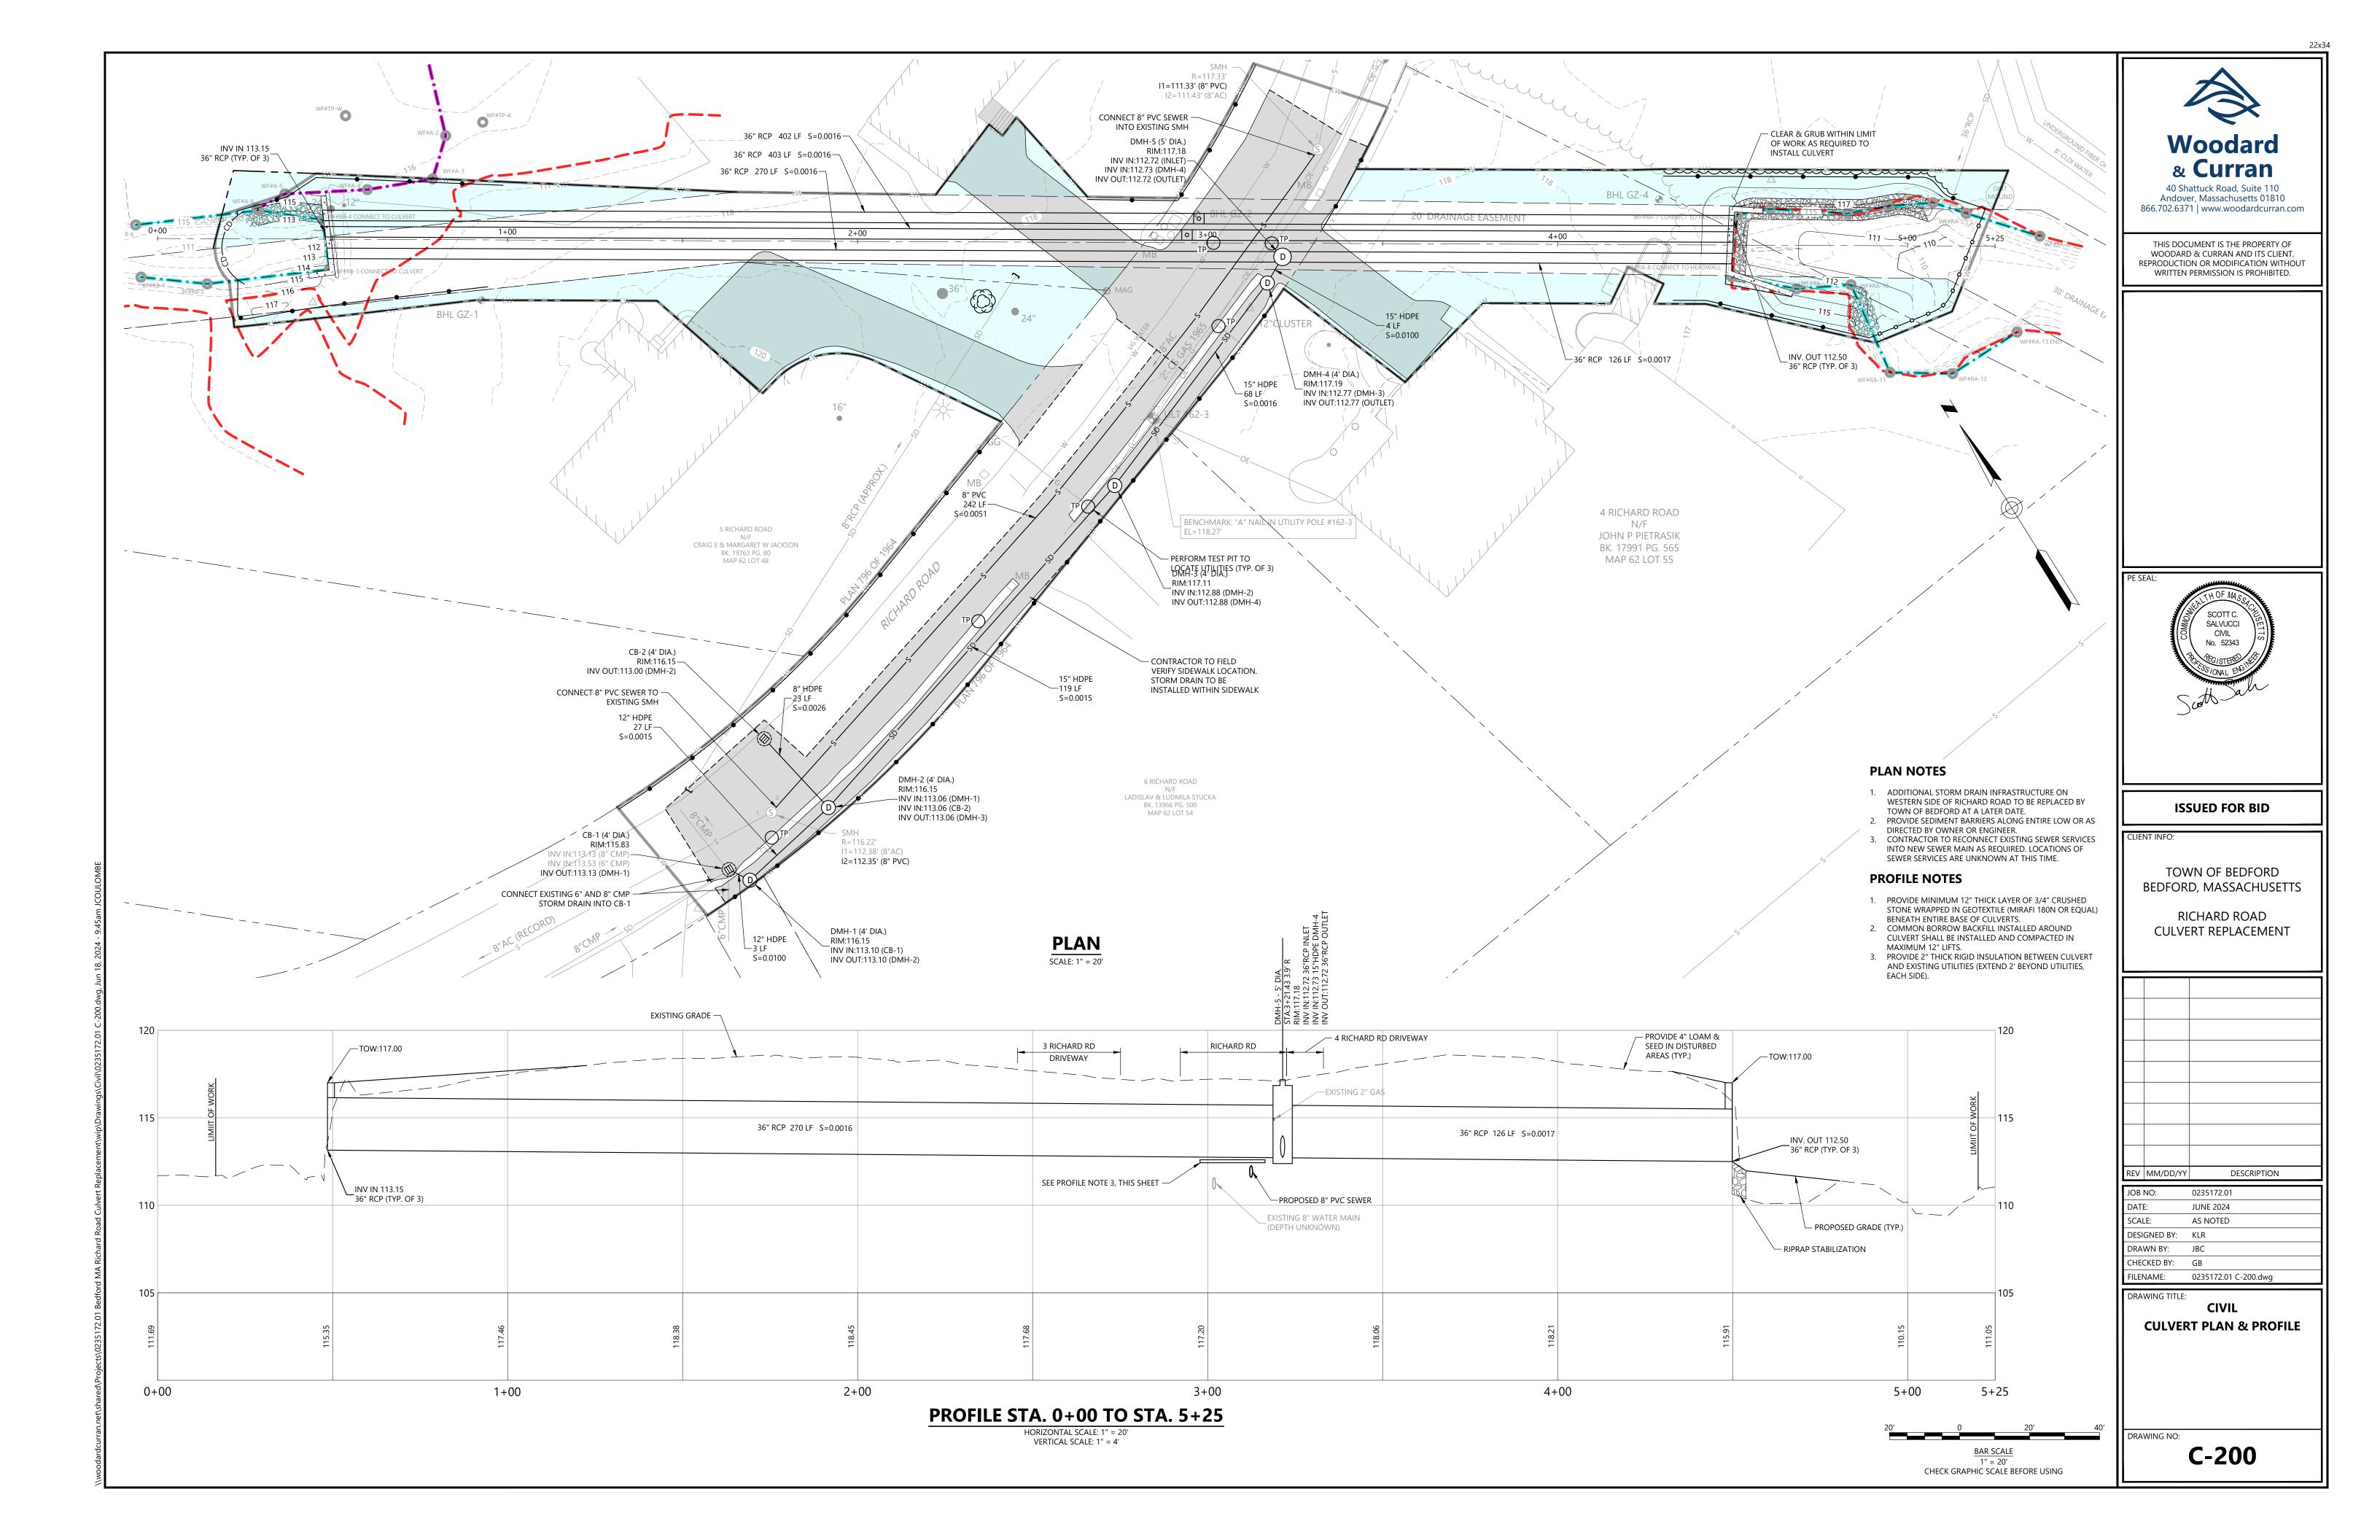

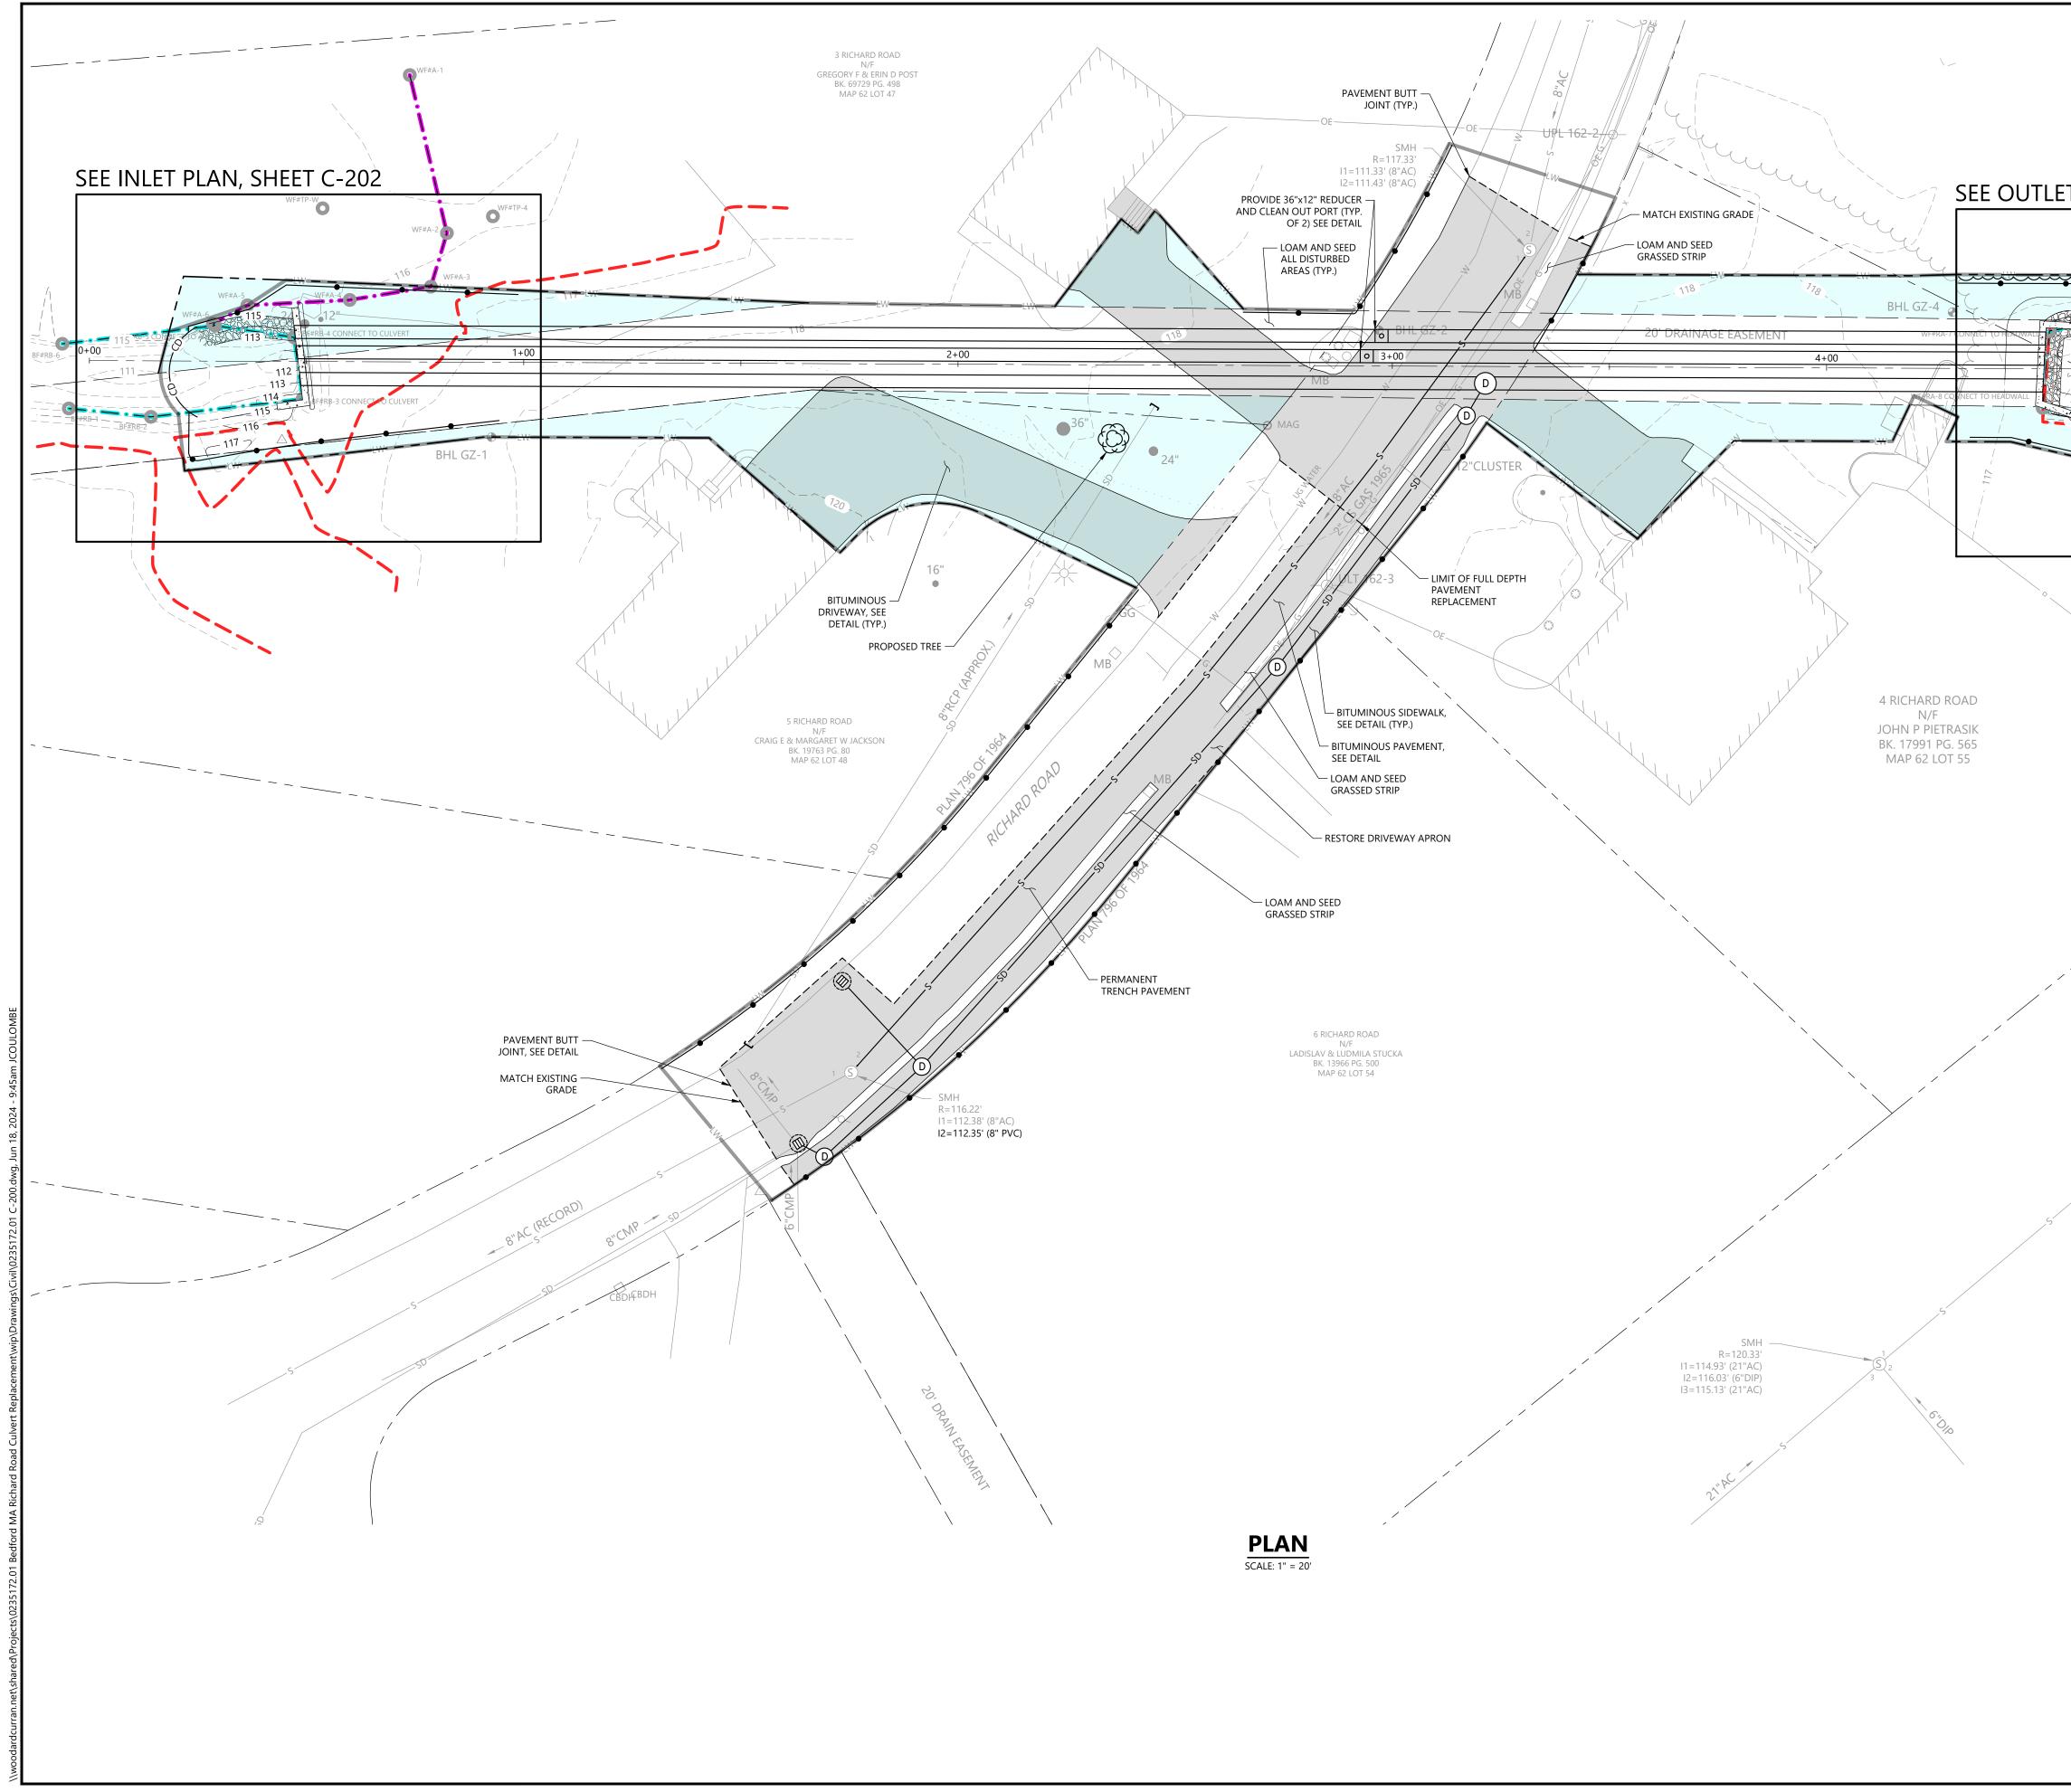

22x3
<image/> <section-header><text><text></text></text></section-header>
PE SEAL:
CLIENT INFO: TOWN OF BEDFORD BEDFORD, MASSACHUSETTS RICHARD ROAD CULVERT REPLACEMENT
REV MM/DD/YY DESCRIPTION JOB NO: 0235172.01 DATE: JUNE 2024 SCALE: AS NOTED DESIGNED BY: KLR DRAWN BY: JBC CHECKED BY: GB FILENAME: 0235172.01 C-200.dwg DRAWING TITLE: CIVIL SITE RESTORATION PLAN DRAWING NO:

odardcurran.net\shared\Projects\0235172.01 Bedford MA Richard Road Culvert Replacement\wip\Drawings\Civil\0235172.01 C-200.dwg, Jun 18, 2024 - 9:45am JCOULOMBE

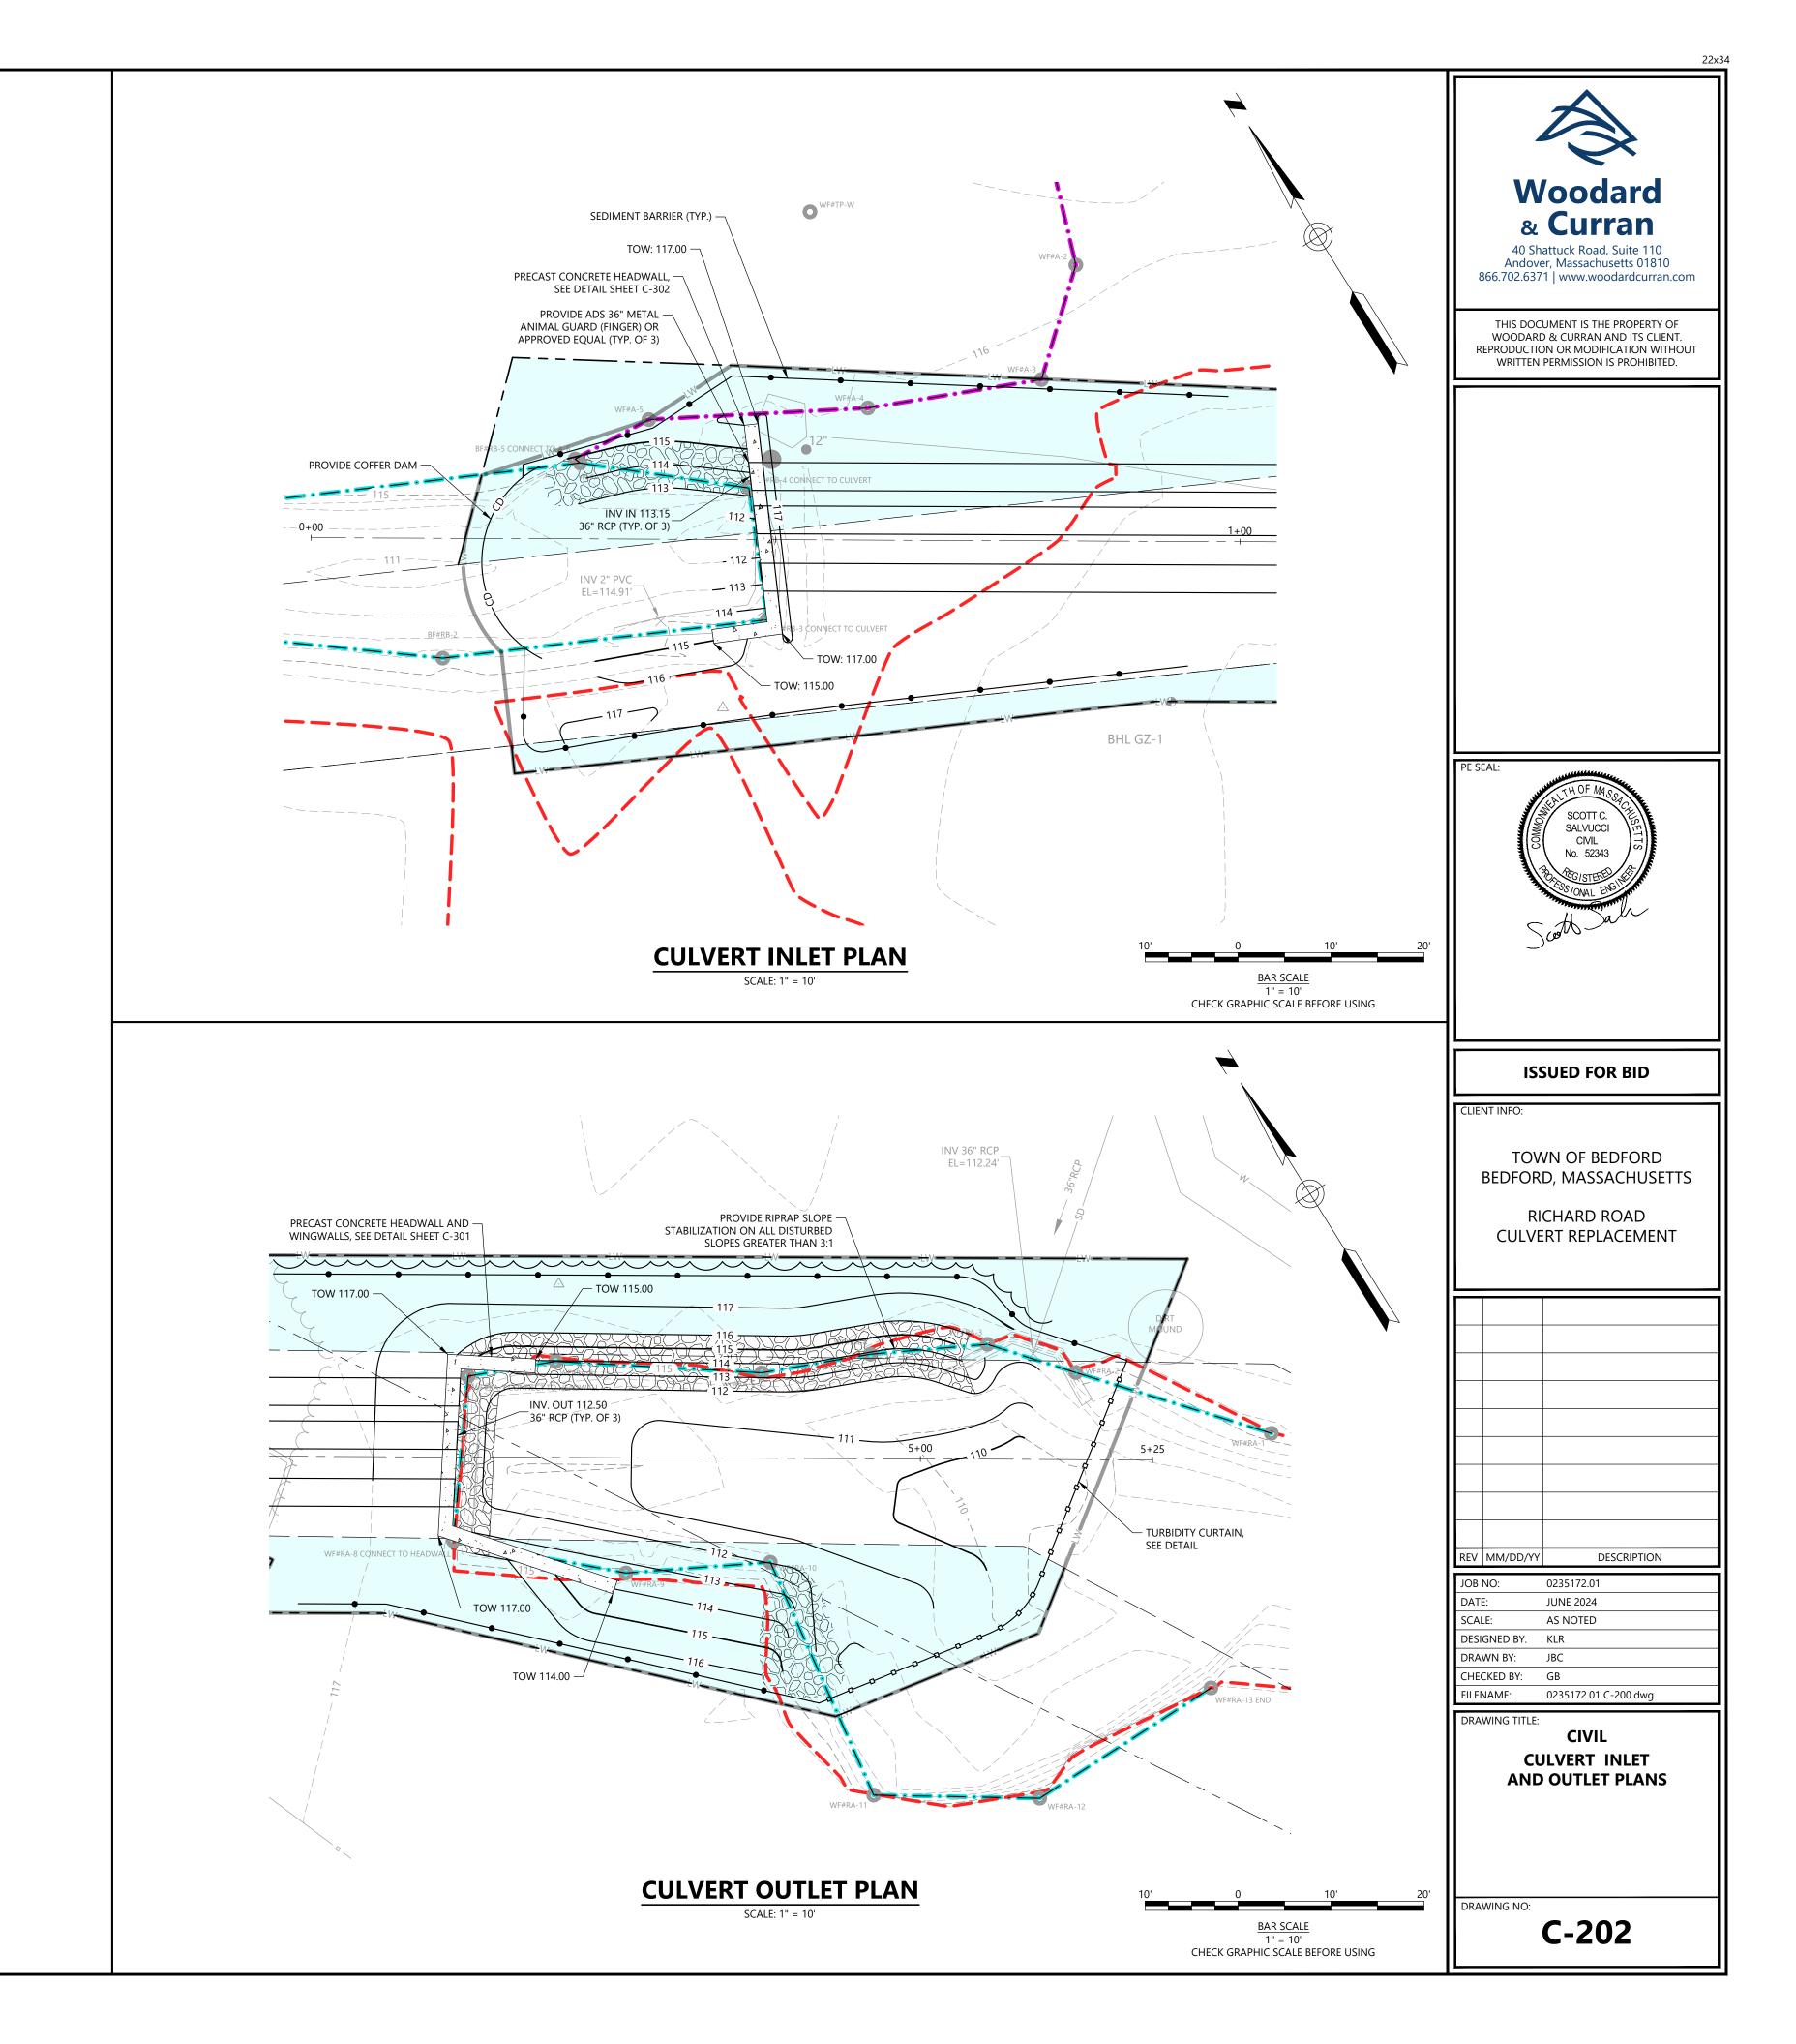

EROSION AND SEDIMENT CONTROL NOTES

Temporary Erosion	Control	
Measure	Dates For Use	Timing, Activity, and Location
Sedimentation Barrier	ALL	Before soil disturbance, install downhill of areas to be disturbed and around material stockpiles.
Up-slope Diversion	ALL	Before soil disturbance, install uphill of areas to be disturbed and material stockpiles.
Catch Basin Protection	ALL	Before soil or pavement disturbance, install ACF Environmental, Inc. High Flow Siltsack, Siltsaver Inlet Filter. or equal, installed per manufacturer's requirements.
Dust Control	ALL	During dry weather, apply water and calcium chloride to control dust.
Temporary Seeding	April 15 to Oct. 15	Soil stockpiles that are not covered and disturbed areas that will not be disturbed again within 14 days. If grass growth provides less than 95% soil coverage by Nov. 1, apply mulch and anchor with erosion control blanket.
Mulch	April 15 to Sept. 15	On all areas of exposed soil prior to rain events apply 100-150 lbs (2.5 bales) per 1,000 sq ft. by mechanical blower.
Winter Mulch	Sept. 16 to Oct. 31	On all areas of exposed soil prior to precipitation apply 150 to 170 lbs. mulch (4 bales) per 1,000 sq. ft. by mechanical blower. Erosion control blanket may be used as a substitute for winter mulch.
	Nov. 1 to April 14	On all areas of exposed soil, apply 150 to 170 lbs. mulch (4 bales) per 1,000 sq. ft. and anchor with netting <u>at the end of each working day.</u> Erosion control blanket may be used as a substitute for winter mulch.
Inspection	Until site is permanently stabilized	Inspect the erosion and sedimentation control measures daily, and after rainfall of half inch or greater in a 24-hour period, and maintain and repair as necessary.

Permanent Erosion Control:

Measure	Dates For Use	Timing, Activity, and Location
Pavement - Base Course - Final Course	When no frost is in ground	Install only in areas shown on the plan, shortly after pavement base is brought to final grade. Install near completion of project.
Permanent Seeding	April 15 to Sept. 15	On final grade areas, within 7 days of grade preparation, prepare topsoil, followed by seed and mulch application.
Dormant Seeding	Sept. 16 to April 15	On final grade areas, with prepared topsoil. Apply seed at double the specified rate on bare soil, and follow with an application of winter mulch.
Ground Cover, Trees, Shrubs	April 15 to Nov. 1	Install with final landscaping.
Permanent Mulch	ALL	Install with final landscaping.

Inspections:


Regular inspections of all erosion	n and sedimentation controls shall be made at least weekly and prior to and
following storm events. Minimu	m inspections shall be made as listed in the table below.


Inspected Item	Look For
Mulched Surfaces	Thin mulch or inadequate application. Wind movement.
Seeded Surfaces	Poor seed germination. Loss of mulch. Development of rivulets.
Sediment Barrier	Sediment build-up to one half the height of the barrier. Undermining of the barrier. Supporting stakes loose, toppled, or unmarked. Breaks in barrier.
Perimeter Diversion	Discharge is to stabilized area. Erosion or breaks in barrier. Supporting stakes loose, toppled or unmarked.
Catch Basin Protection	Sediment build-up and structure blockages. Slow flow/Ponding water. Breaks in fabric or voids in barrier.
Dewatering Filter	Breaks in fabric or supporting structure. Slow flow, indicating high sediment build-up.
Construction Entrance	Sedimentation of roadways. Off-site dust complaints.

DEWATERING NOTES

- 1. LOCATE DISCHARGE SITE ON FLAT UPLAND AREAS AS FAR AWAY AS POSSIBLE FROM STREAMS,
- WETLANDS, OTHER RESOURCES AND POINTS OF CONCENTRATED FLOW. NEVER DISCHARGE TO AREAS THAT ARE BARE OR NEWLY VEGETATED.
- DIRT BAG MATERIAL BASED ON PARTICLE SIZE IN DIRTY WATER, I.E., FOR COARSE PARTICLES A WOVEN MATERIAL;
- FOR SILTS/CLAYS A NON-WOVEN MATERIAL.
- DO NOT OVER PRESSURIZE DIRT BAG OR USE BEYOND CAPACITY. CHANNELS DUG FOR DISCHARGING WATER FROM THE EXCAVATED AREA NEED TO BE STABLE. IF FLOW VELOCITIES CAUSE EROSION
- WITHIN THE CHANNEL THEN A DITCH LINING SHOULD BE USED. 6. BUCKETED WATER SHOULD BE DISCHARGED IN A STABLE MANNER TO THE SEDIMENT REMOVAL AREA. A SPLASH PAD OF RIPRAP UNDERLAIN WITH GEOTEXTILE MAY BE NECESSARY TO PREVENT SCOURING
- OF SOIL. 7. DEWATERING IN PERIODS OF INTENSE, HEAVY RAIN, WHEN THE INFILTRATIVE CAPACITY OF THE SOIL IS
- EXCEEDED, SHOULD BE AVOIDED.
- 8. INSTALL DIVERSION DITCHES OR BERMS TO MINIMIZE THE AMOUNT OF CLEAN STORMWATER RUNOFF ALLOWED INTO THE EXCAVATED AREA.
- DURING THE ACTIVE DEWATERING PROCESS, INSPECTION OF THE DEWATERING FACILITY SHOULD BE REVIEWED FREQUENTLY. SPECIAL ATTENTION SHOULD BE PAID TO THE BUFFER AREA FOR ANY SIGN OF EROSION AND CONCENTRATION OF FLOW THAT MAY COMPROMISE THE BUFFER AREA. OBSERVE WHERE POSSIBLE THE VISUAL QUALITY OF THE EFFLUENT AND DETERMINE IF ADDITIONAL TREATMENT CAN BE PROVIDED.
- 10. EROSION CONTROL REQUIRED AROUND DEWATERING DISCHARGE SEDIMENT CONTROL DEVICE.




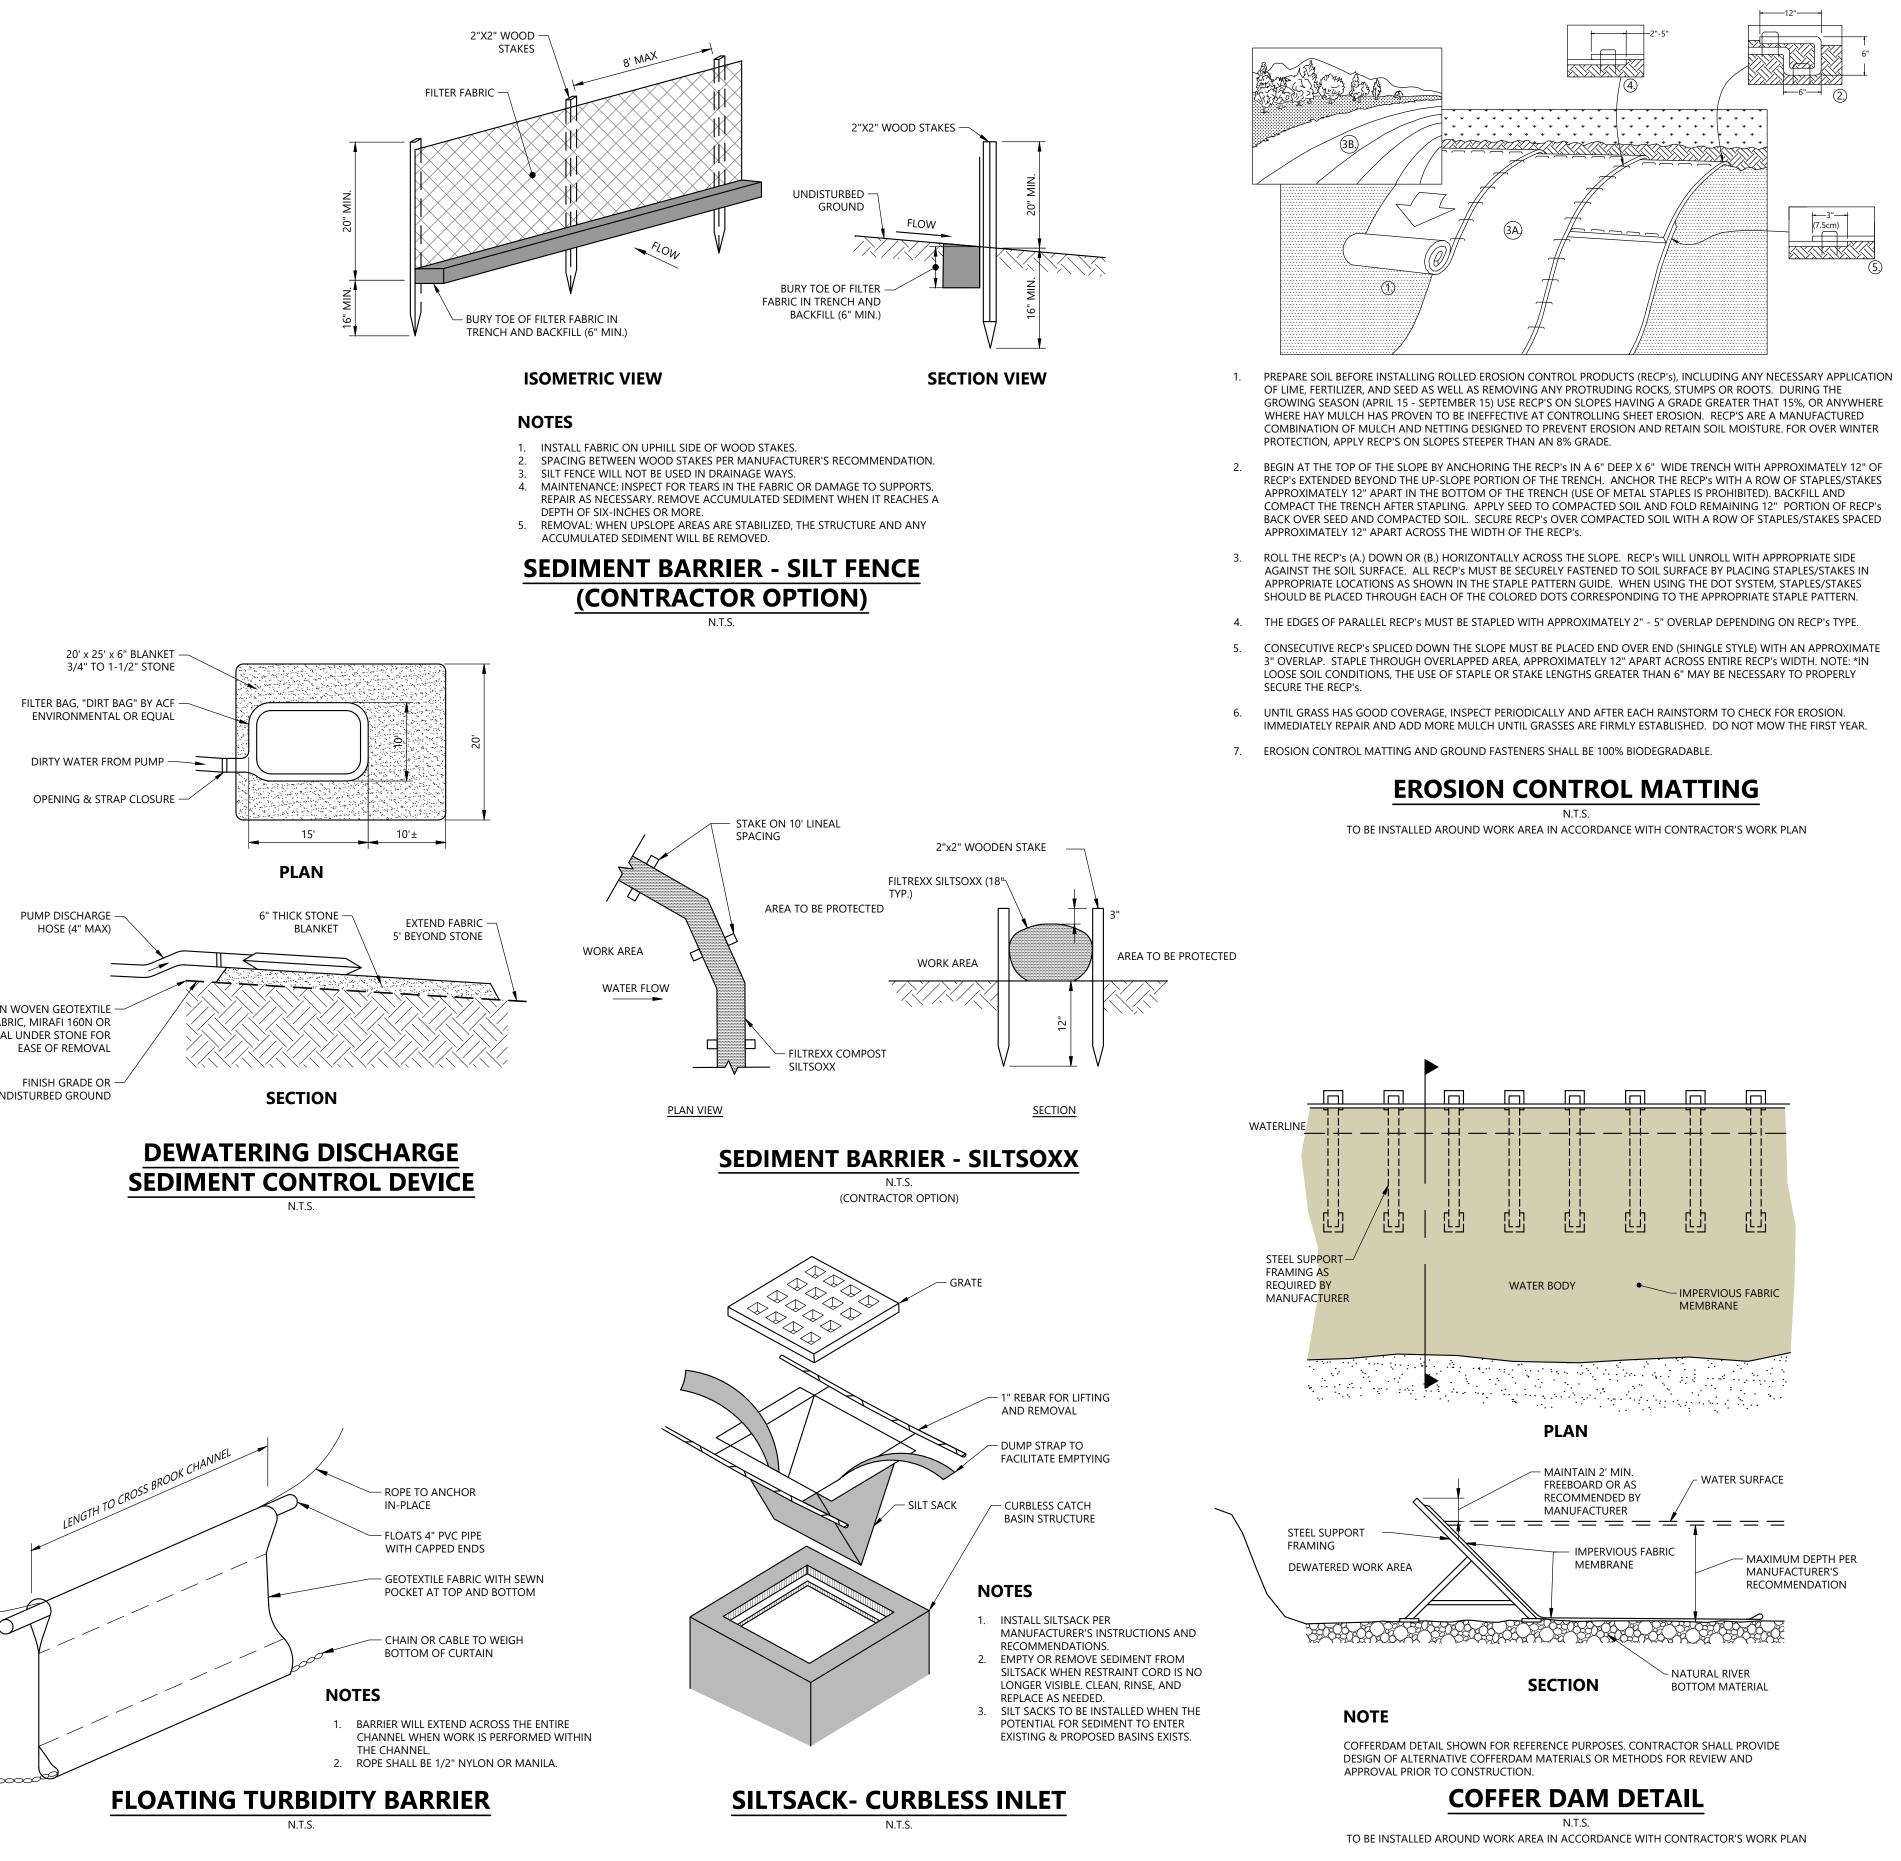


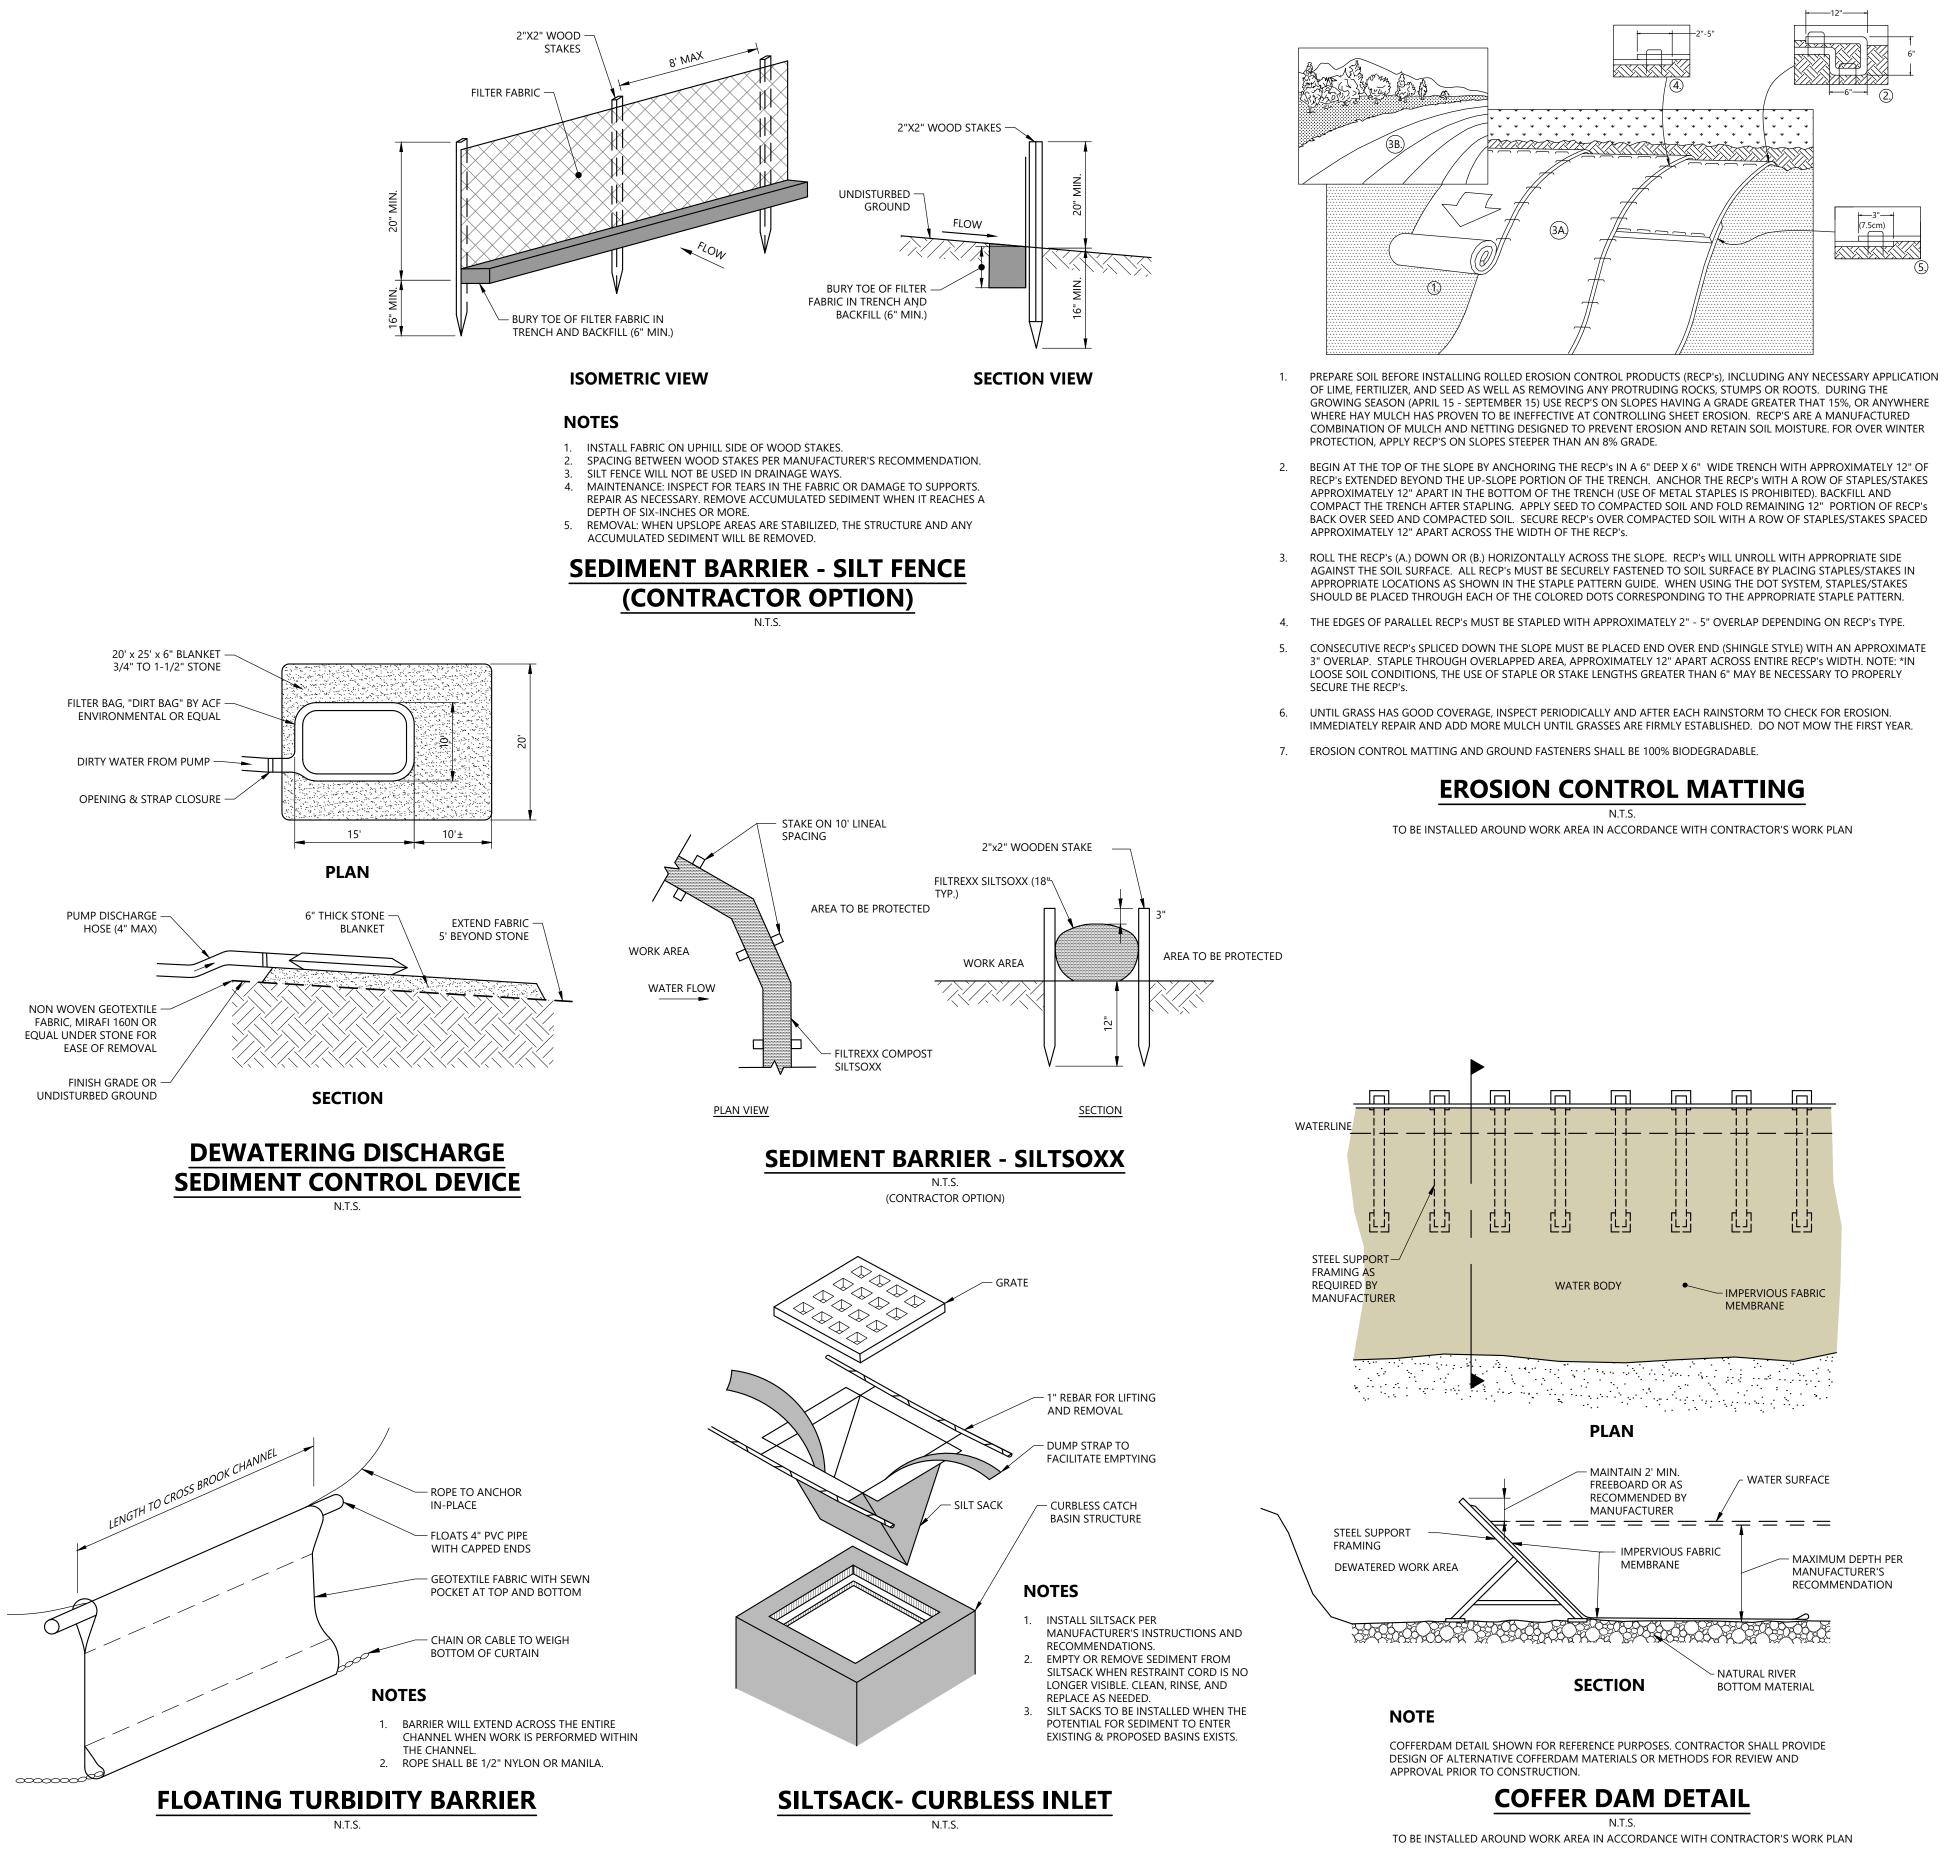







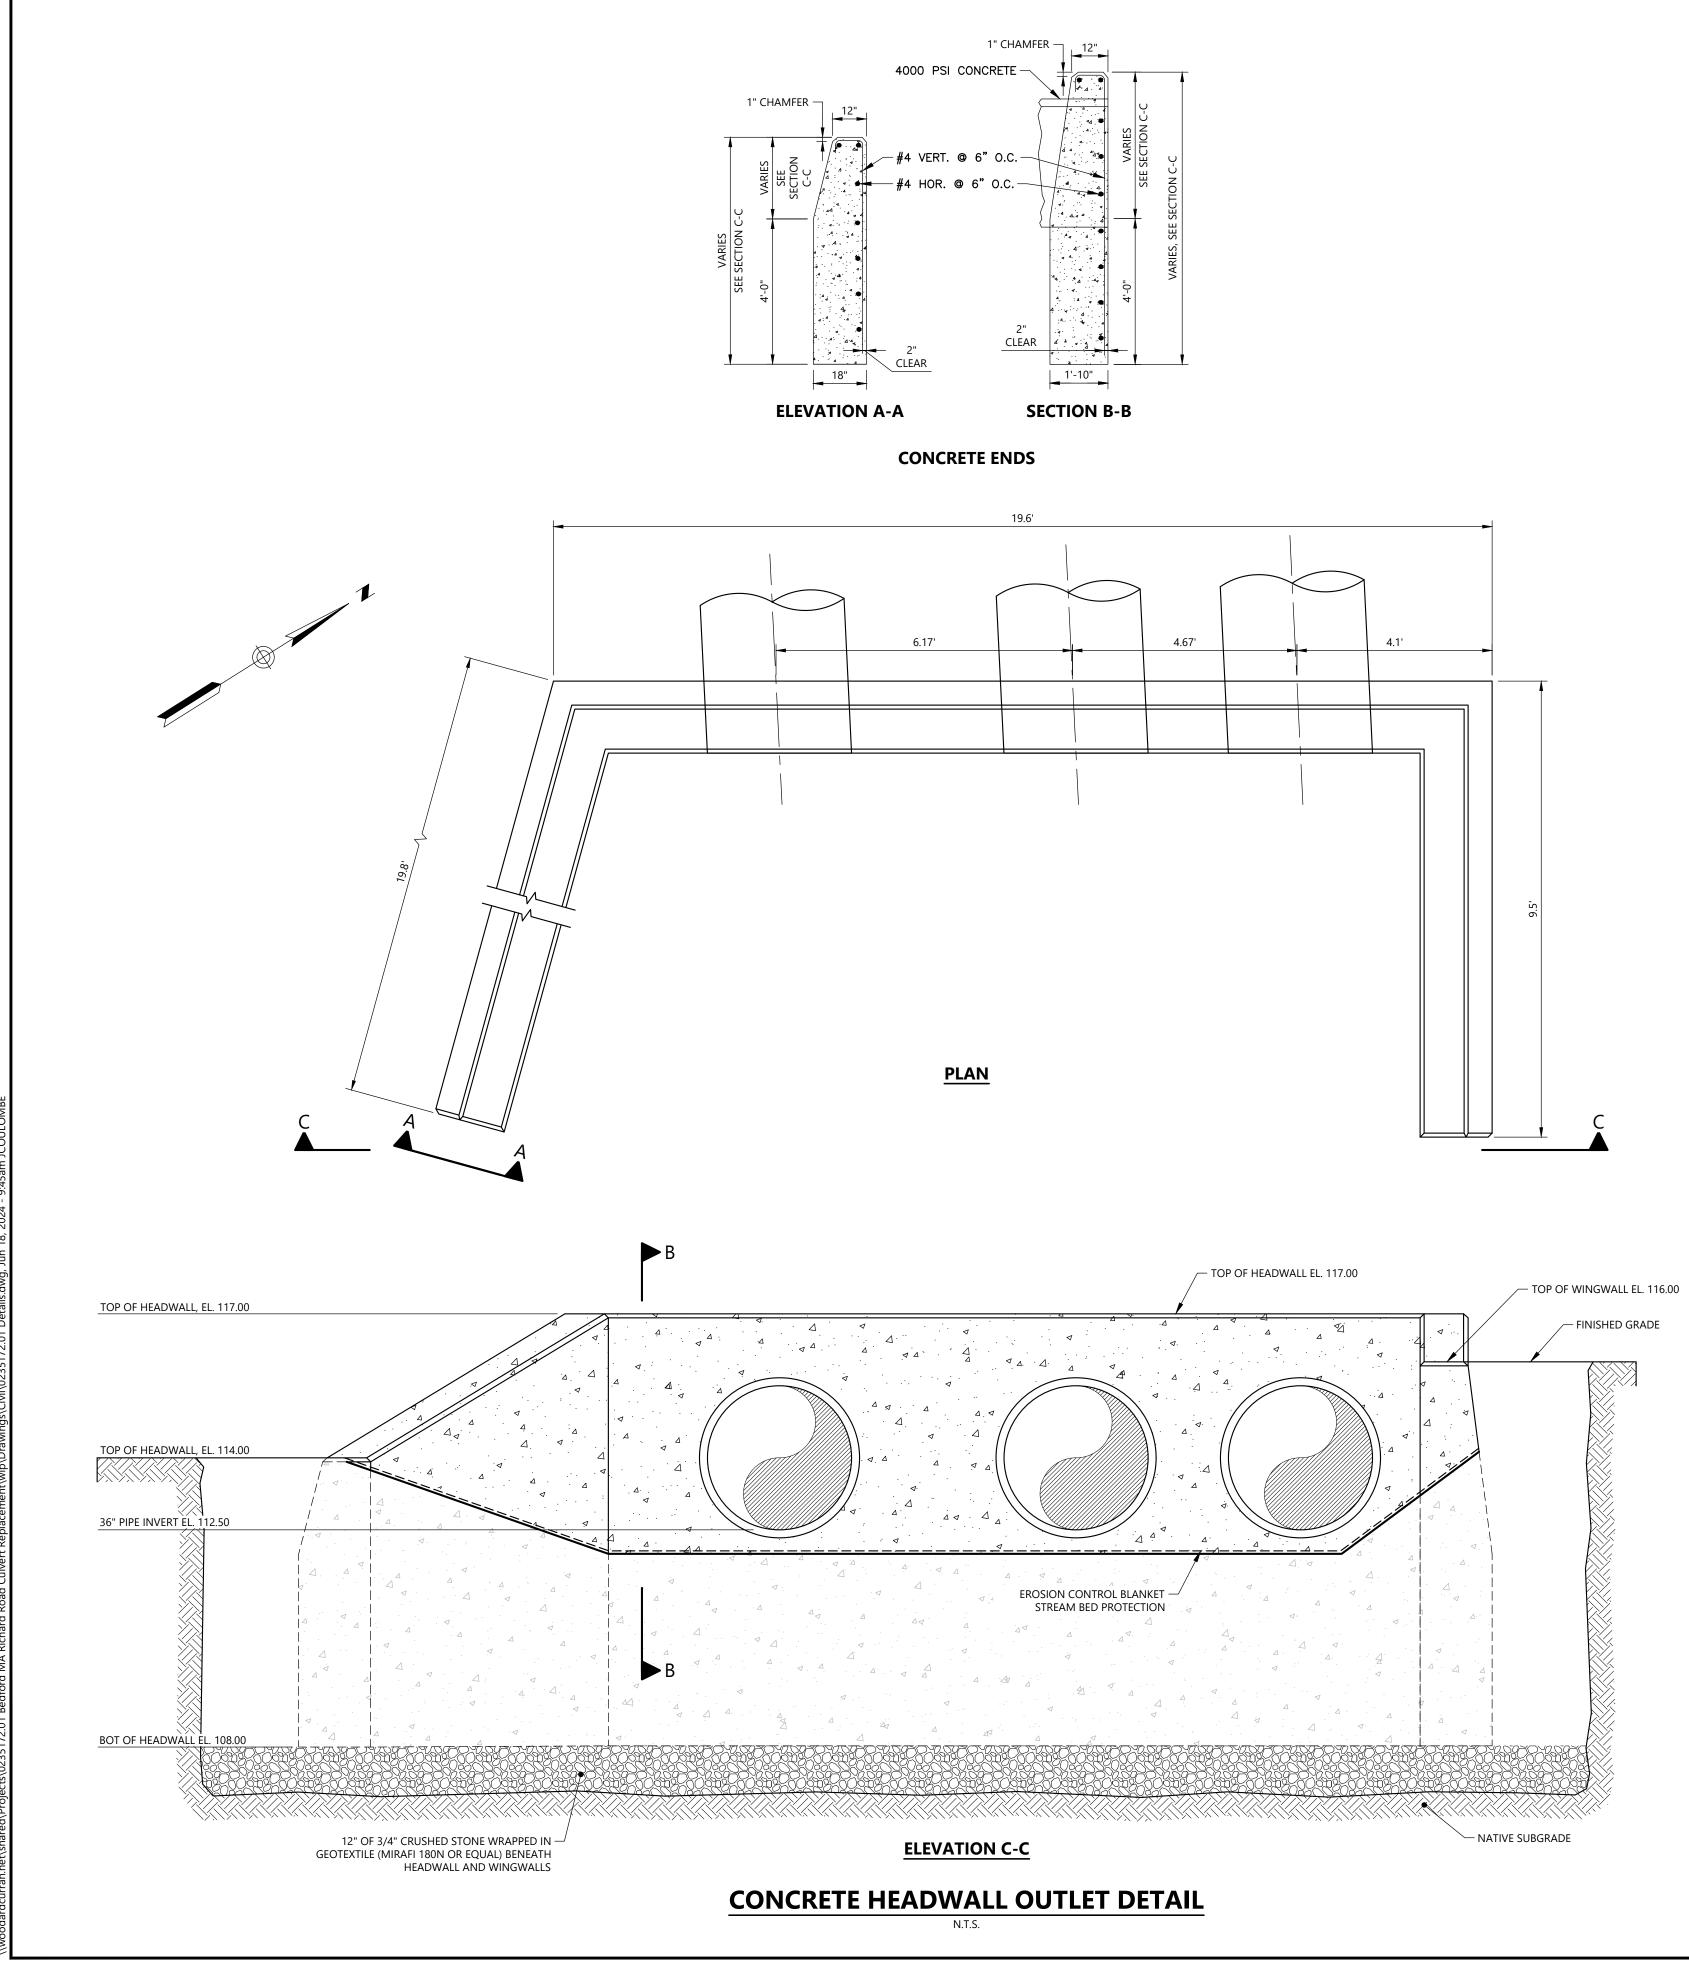


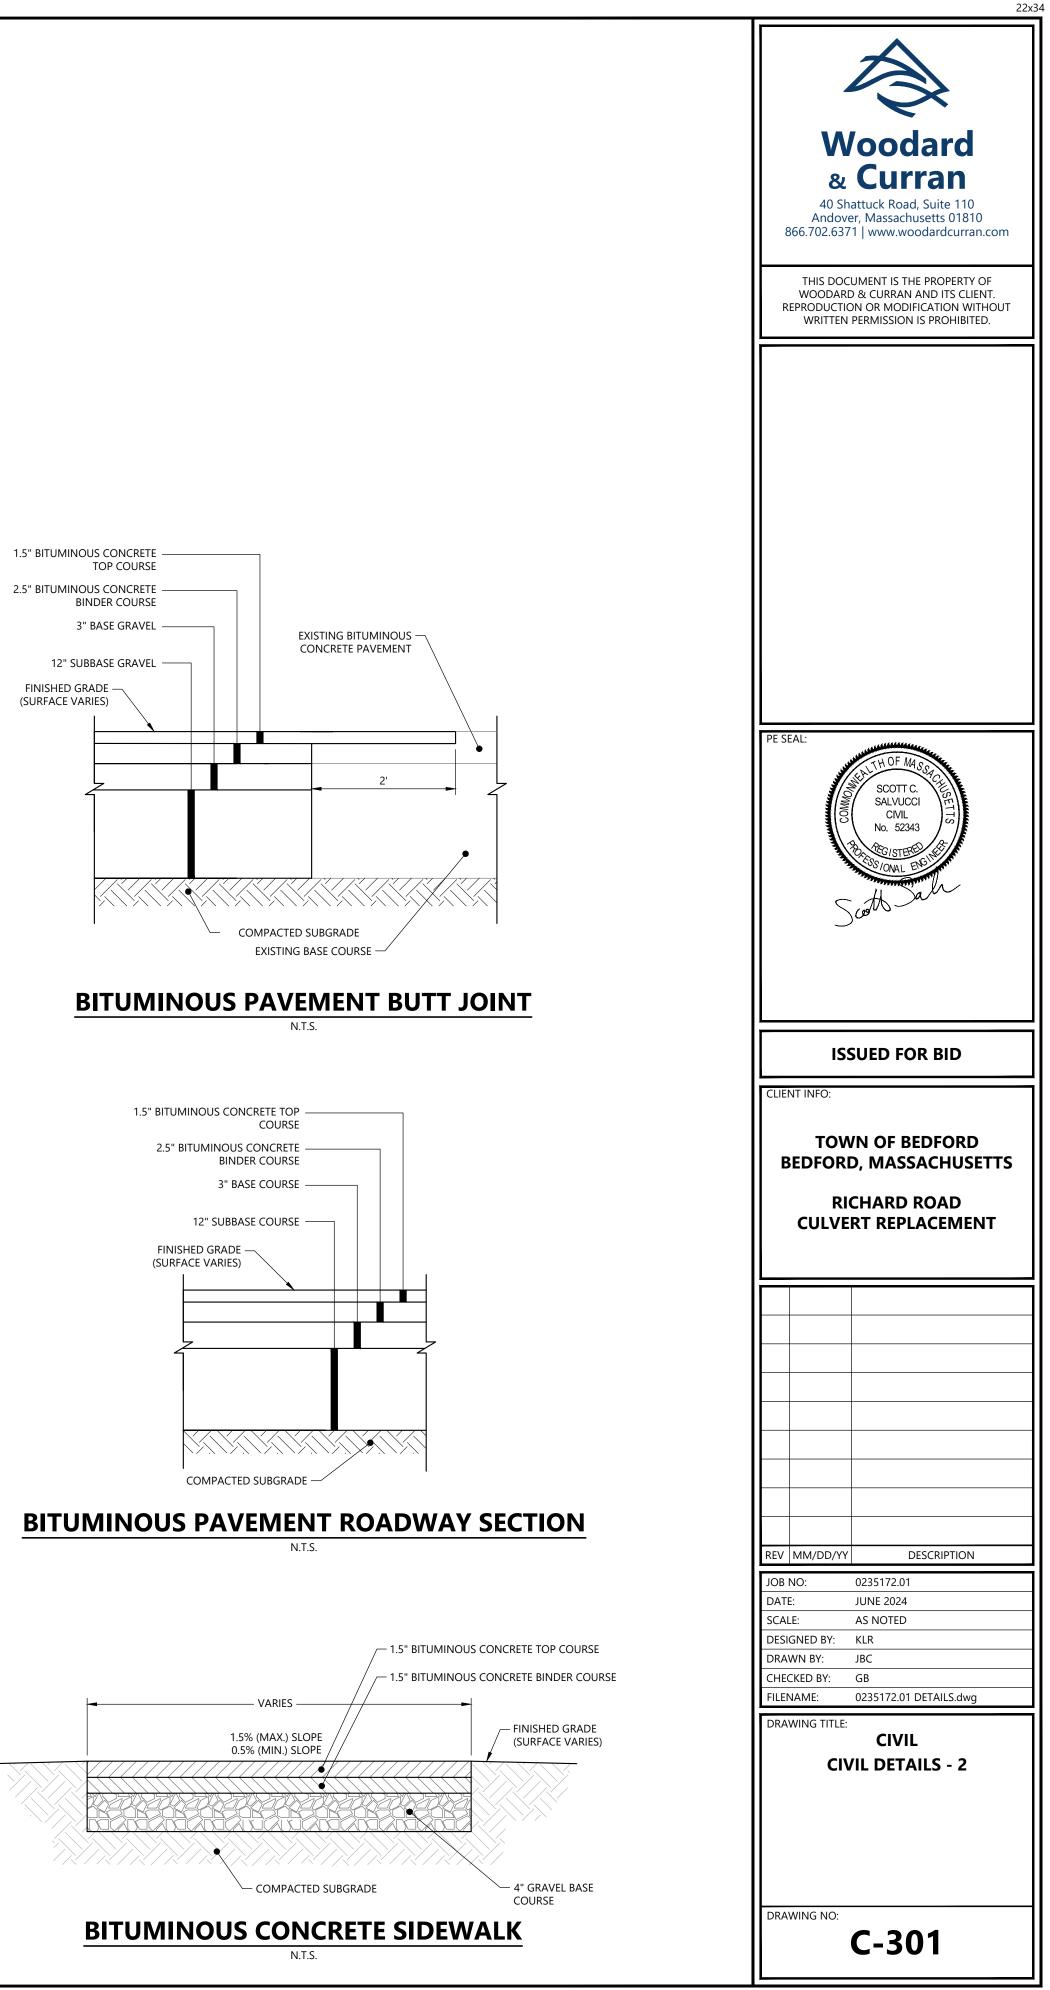


(SURFACE VARIES)
_
1
COMPACTE

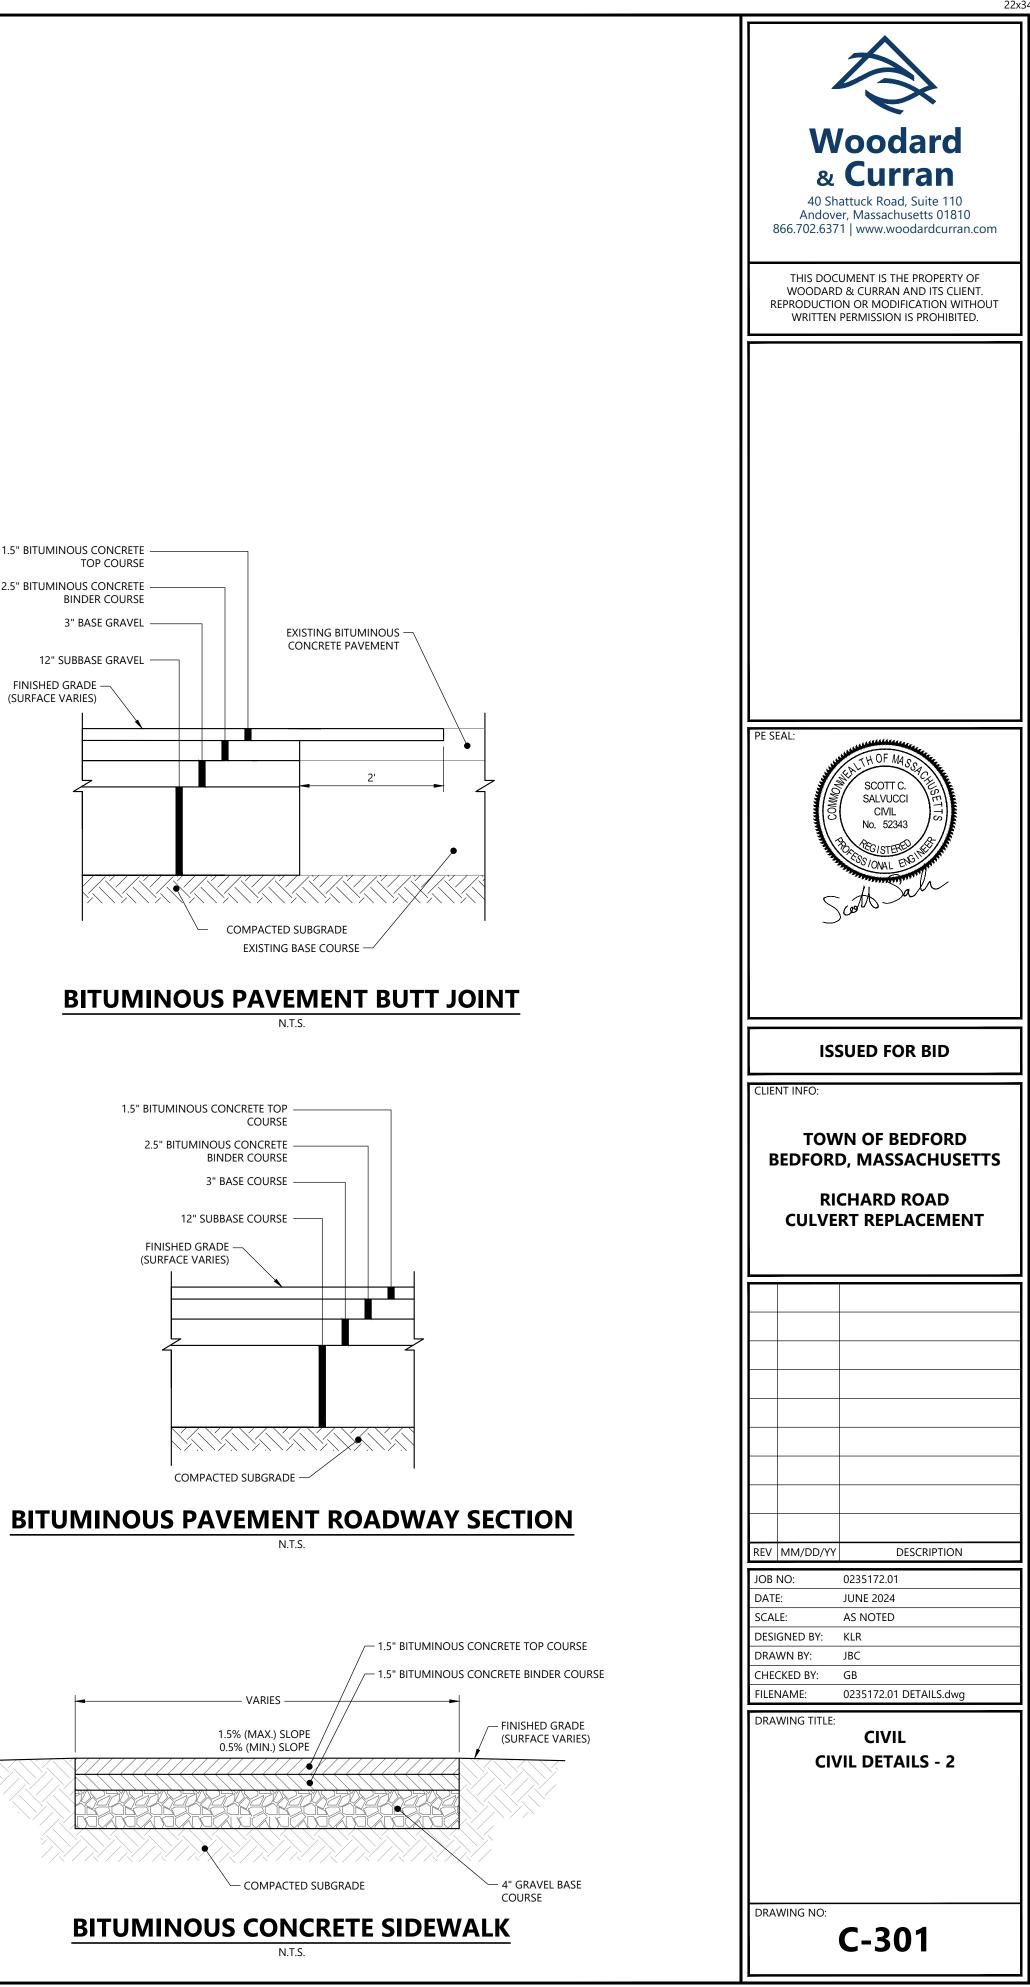


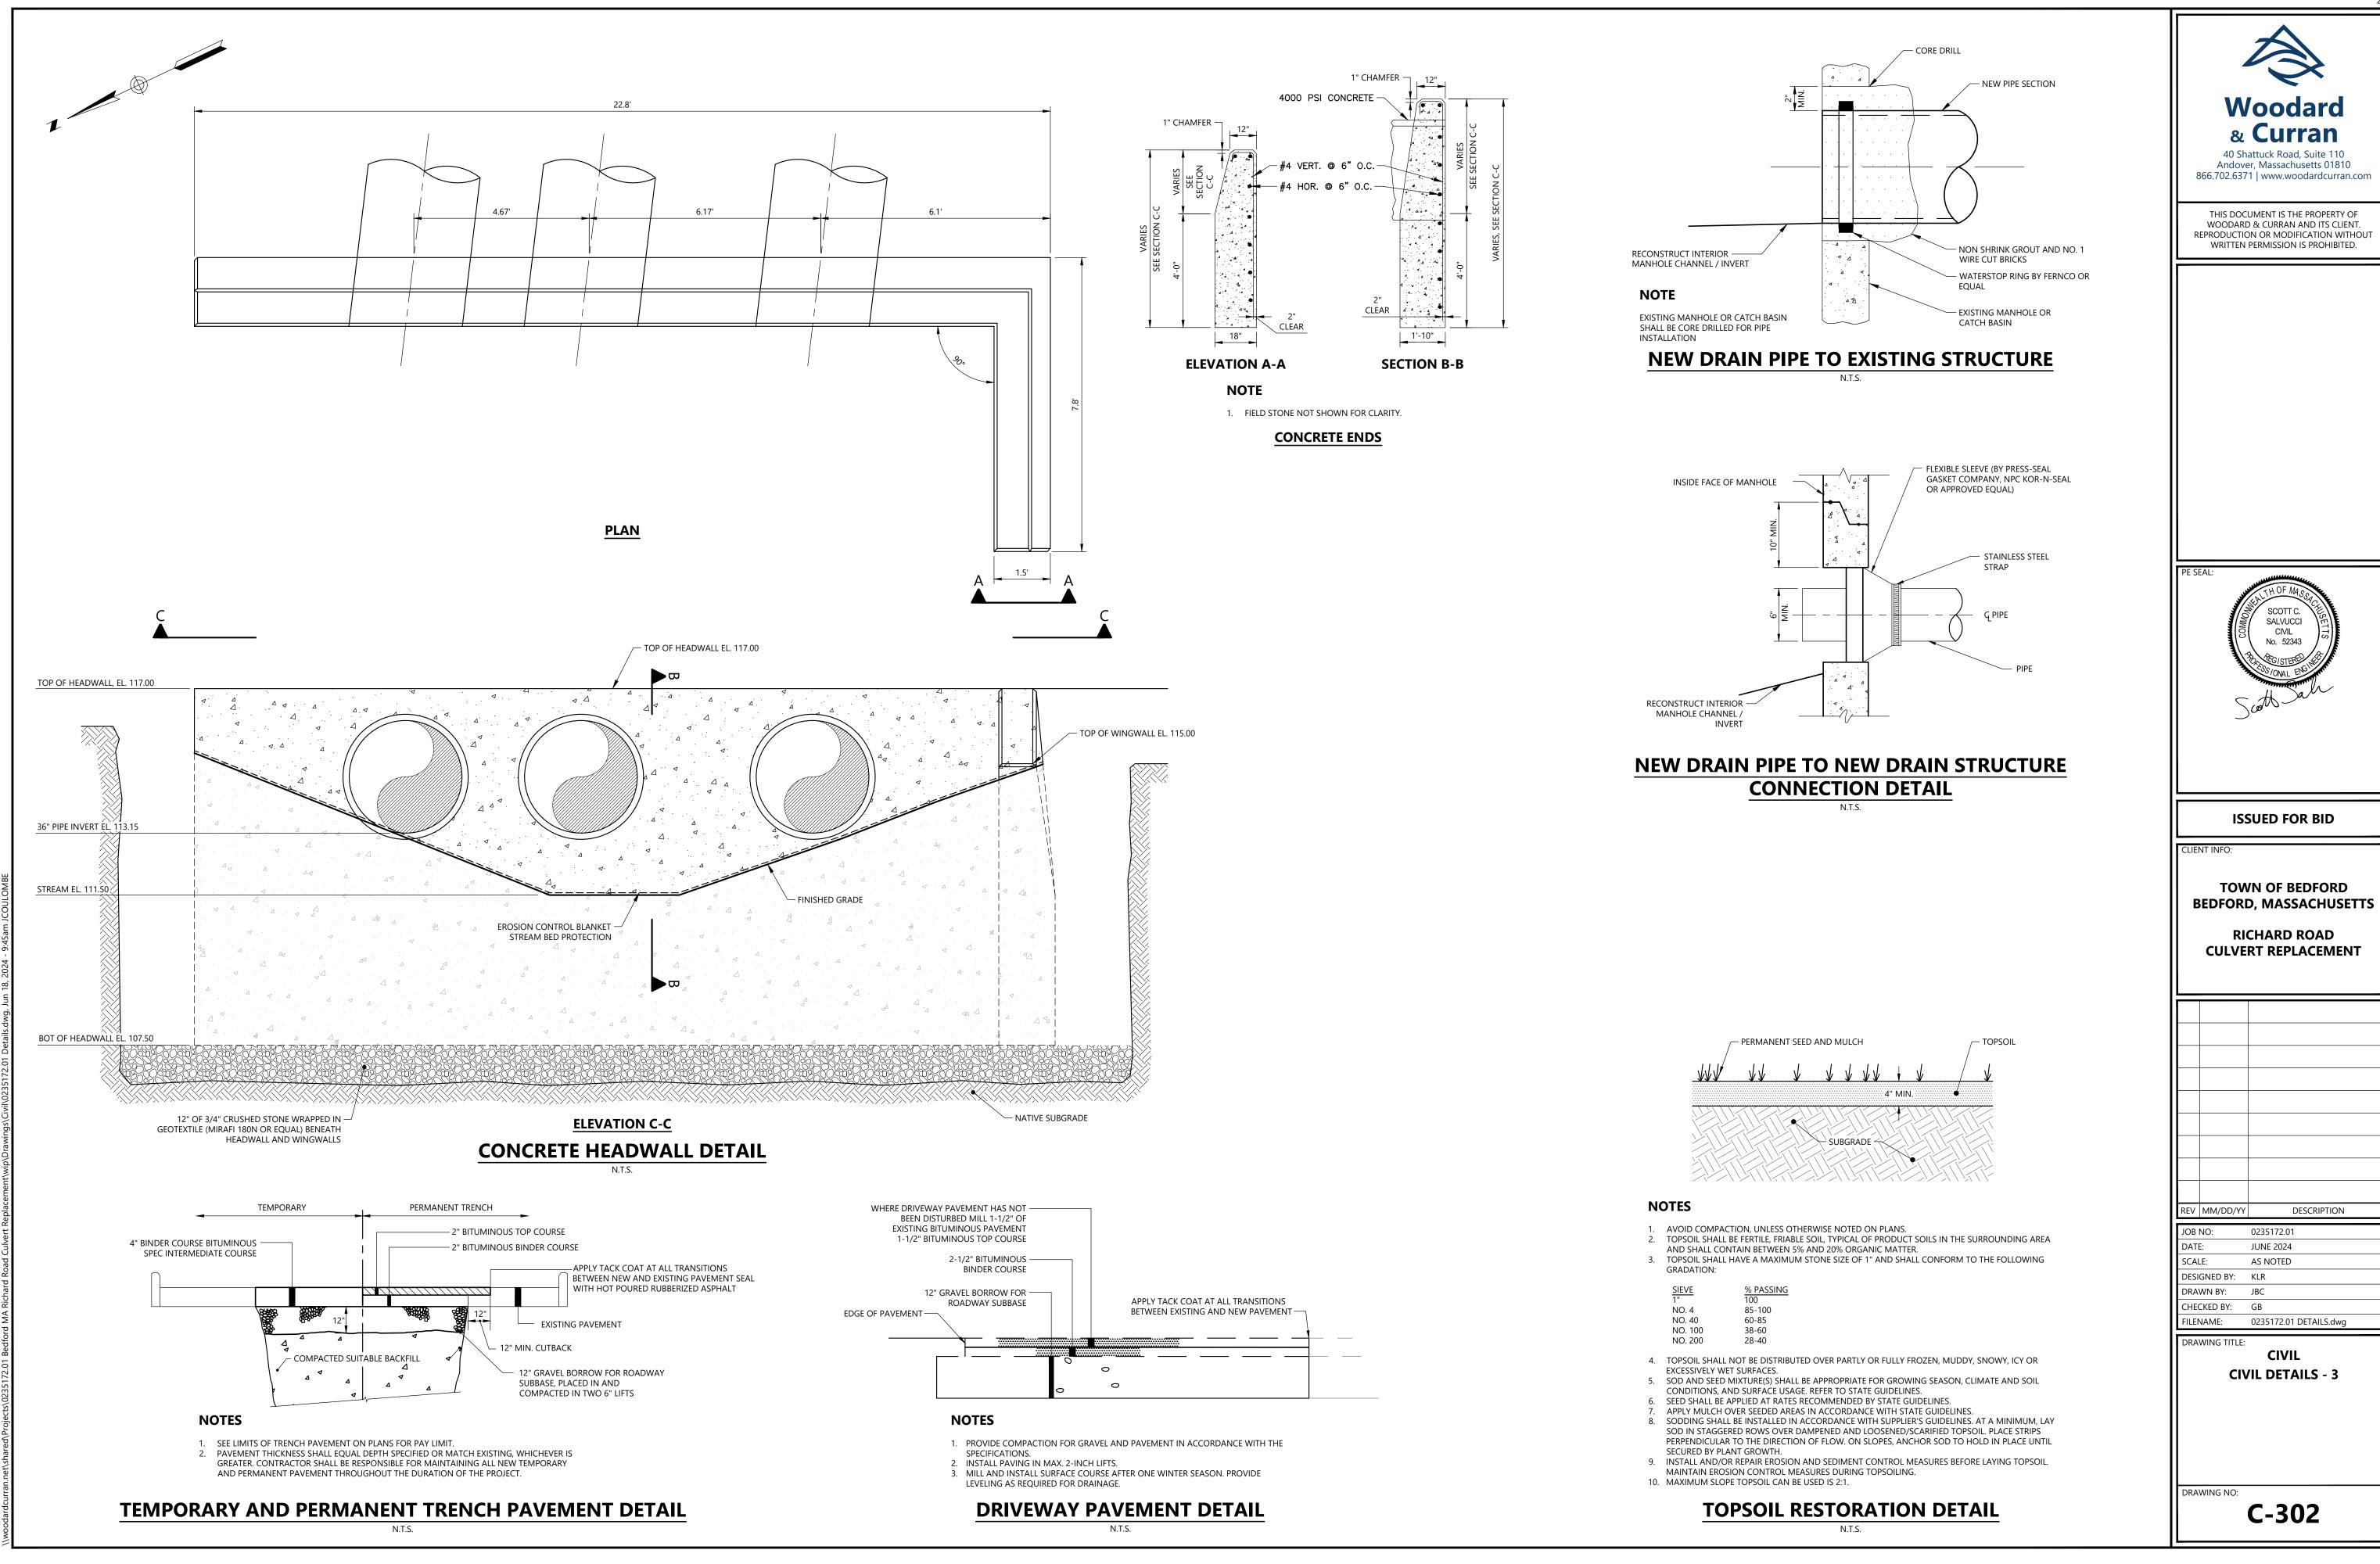

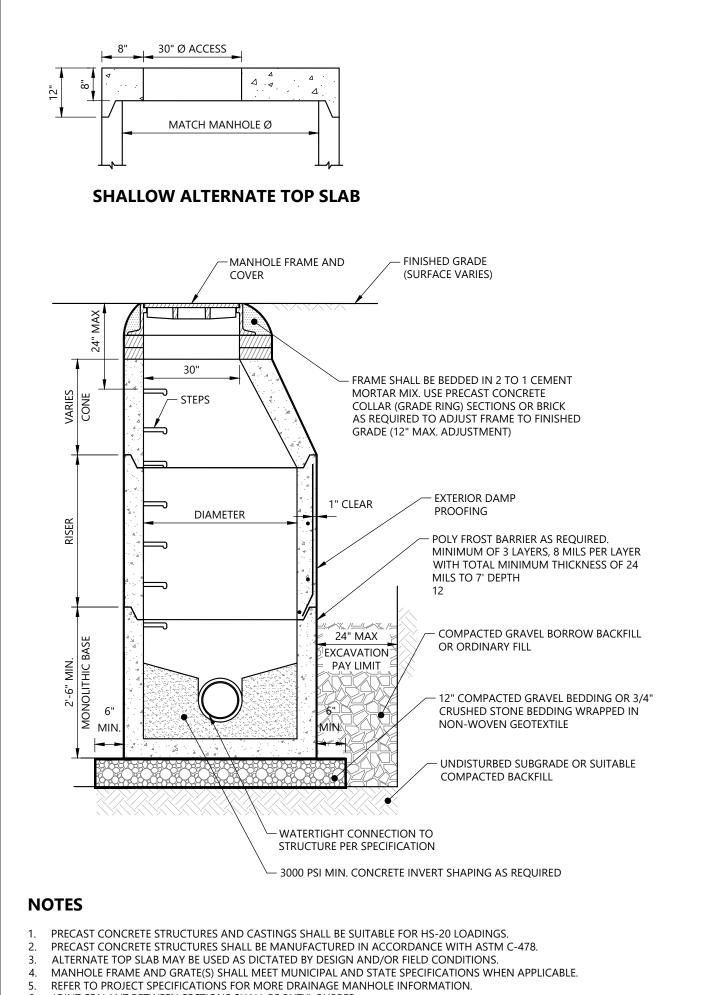

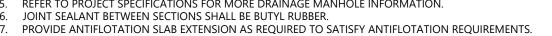




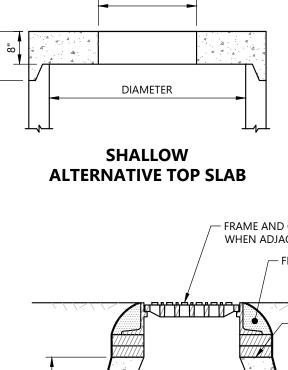

24"Ø (SINGLE CATCH BASIN GRATE AND FRAME)

24" X 48" (DOUBLE CATCH BASIN GRATE AND FRAME)

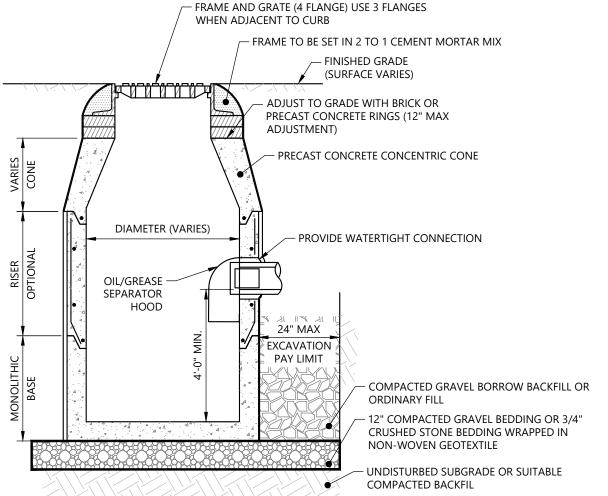


NOTES

- PRECAST CONCRETE STRUCTURES AND CASTINGS SHALL BE SUITABLE FOR HS-20 LOADINGS.
- 3. ALTERNATE TOP SLAB MAY BE USED AS DICTATED BY DESIGN AND/OR FIELD CONDITIONS. 4. JOINT SEALANT BETWEEN PRECAST SECTIONS SHALL BE BUTYL RUBBER.
- 5. PROVIDE MINIMUM 24" DIAMETER OPENING.
 - PRECAST CONCRETE CATCH BASIN N.T.S.

2. PRECAST CONCRETE STRUCTURES SHALL BE MANUFACTURED IN ACCORDANCE WITH ASTM C-478.

6. PROVIDE ANTIFLOATATION SLAB EXTENSION AS REQUIRED TO SATISFY ANTIFLOATATION REQUIREMENTS.

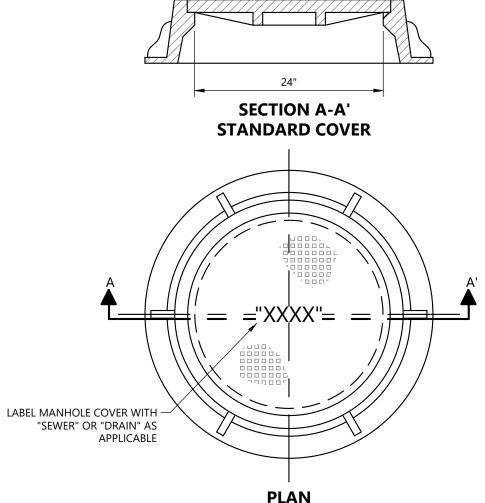

STANDARD SEWER/DRAIN MANHOLE FRAME AND COVER

