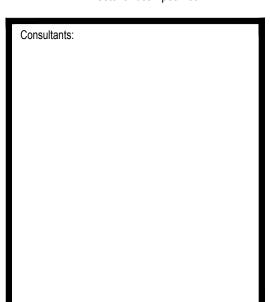


Weston & Sampson



Revisi	ons:	
No.	Date	Description
Seal:	JULIA	NTH OF MAC
	COMMON	SCOTT R. BRUSO STRUCTURAL No. 48061

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GENERAL NOTES

<u>DESIGN</u>

IN ACCORDANCE WITH THE 2020 AMERICAN ASSOCIATION OF STATE HIGHWAY AND TRANSPORTATION OFFICIALS LRFD BRIDGE DESIGN SPECIFICATIONS, WITH CURRENT INTERIM SPECIFICATIONS THROUGH 2021, FOR HL-93 LOADING.

EXISTING CONDITIONS:

DIMENSIONS SHOWN AND DETAILS DEPICTED ARE BASED UPON THE ORIGINAL BRIDGE PLANS AND ARE NOT GUARANTEED. THE CONTRACTOR SHALL DETERMINE AND ESTABLISH ALL DIMENSIONS AND DETAILS NECESSARY FOR COMPLETION OF ALL WORK BY FIELD MEASUREMENT AND SURVEY. THE CONTRACTOR SHALL BE RESPONSIBLE AND NOT ORDER ANY MATERIAL OR COMMENCE ANY FABRICATION UNTIL HE/SHE HAS MADE THE REQUIRED MEASUREMENTS ON THE ACTUAL STRUCTURE AND THE EXTENT OF THE PROPOSED WORK HAS BEEN APPROVED BY THE ENGINEER.

BENCH MARK:

MAG NAIL IN UTILITY POLE ELEV. 399.51. ELEVATIONS ARE BASED ON THE NORTH AMERICAN VERTICAL DATUM (NAVD) OF 1988.

DATE:

TO BE PLACED ON THE INSIDE FACE OF THE NORTHEAST AND SOUTHWEST HIGHWAY GUARDRAIL TRANSITIONS. A SHEET SHOWING SIZE AND CHARACTER OF NUMERALS WILL BE FURNISHED. THE DATE USED SHALL BE THE LATEST YEAR OF CONTRACT COMPLETION AS OF THE DATE THE FIRST HIGHWAY GUARDRAIL TRANSITION IS CONSTRUCTED. BOTH HIGHWAY GUARDRAIL TRANSITIONS SHALL FEATURE THE SAME DATE.

SURVEY:

TOPOGRAPHICAL INFORMATION BASED ON THE GROUND SURVEY PERFORMED BY WESTON & SAMPSON PE, LS, LA, PC. IN JANUARY 2019. COORDINATES, IN US SURVEY FEET, ARE REFERENCED TO THE NORTH AMERICAN DATUM (NAD) 1983, (2011), EPOCH 2010.00, BASED ON THE KeyNetGPS VIRTUAL REFERENCE SYSTEM.

SCALES:

SCALES NOTED ON THE PLANS ARE NOT APPLICABLE TO REDUCED SIZE PRINTS. DIVIDE SCALES BY 2 FOR HALF—SIZE PRINTS (A3).

FOUNDATIONS:

FOUNDATIONS MAY BE ALTERED, IF NECESSARY, TO SUIT CONDITIONS ENCOUNTERED DURING CONSTRUCTION. WITH THE APPROVAL OF THE ENGINEER.

UNSUITABLE MATERIALS:

ALL UNSUITABLE MATERIAL SHALL BE REMOVED WITHIN THE LIMITS OF THE FOUNDATIONS OF THE STRUCTURE, AS DIRECTED BY THE ENGINEER.

CONCRETE:

ALL CONCRETE SHALL BE 4000 PSI CONCRETE, EXCEPT AS NOTED BELOW:
CAST-IN-PLACE SIDEWALK, SAFETY CURB AND PRECAST HIGHWAY GUARDRAIL
TRANSITIONS SHALL BE 5000 PSI HP CONCRETE.

4000 PSI, 1.5 IN, 565 CEMENT CONCRETE......PRECAST CULVERT, CURTAIN WALLS, WINGWALLS, CAST—IN—PLACE WINGWALL CONNECTION, APPROACH

5000 PSI, 3/4 IN, 685 HP CEMENT CONCRETE......PRECAST HIGHWAY GUARDRAIL TRANSITIONS, CAST—IN—PLACE SIDEWALK, SAFETY CURB

RFINFORCEMENT:

REINFORCING STEEL SHALL CONFORM TO THE REQUIREMENTS OF AASHTO M31 GRADE 60. UNLESS OTHERWISE NOTED ON THE CONSTRUCTION DRAWINGS, ALL BARS SHALL BE LAPPED AS FOLLOWS:

MODIFICATION CONDITION	#4 BARS	#5 BARS	#6 BARS	#7 BARS
1. NONE	16"	" 19"	23"	" 27"
2. 12" OF CONCRETE BELOW BAR	20"	25"	30"	35"
3. EPOXY COATED BARS, COVER < 3d _b ,	23"	29"	34"	40"
OR CLEAR SPACING < 6db				
4. COATED BARS, ALL OTHER CASES	18"	23"	27"	32"
5. CONDITION 2. AND 3.	26"	32"	39"	52"
6. CONDITION 2. AND 4.	24"	30"	36"	44"

ALL OTHER BARS SHALL BE LAPPED AS SHOWN ON THE CONSTRUCTION DRAWINGS

EPOXY COATED BARS:

ALL REINFORCING BARS AND SUPPORTING DEVICES SHALL BE COATED UNLESS NOTED OTHERWISE.

UTILITIES:

THE CONTRACTOR SHALL LOCATE AND PROTECT FROM DAMAGE ALL EXISTING UTILITIES.

SUGGESTED CONSTRUCTION SEQUENCE:

- 1. INSTALL EROSION CONTROLS.
- 2. INSTALL THE DETOUR SIGNAGE AND CLOSE THE ROAD AND BRIDGE.
- 3. CLEAR AND GRUB, REMOVE TREES, AND INSTALL TREE PROTECTION AS INDICATED.
- 4. INSTALL 36" TEMPORARY PLASTIC DIVERSION PIPE.
- 5. INSTALL TEMPORARY COFFERDAM ON UPSTREAM AND DOWNSTREAM SIDES OF THE BRIDGE AND RELOCATE FLOW INTO THE TEMPORARY DIVERSION PIPE.
- 6. DEMOLISH AND REMOVE EXISTING BRIDGE SUPERSTRUCTURE AND GUARDRAIL.
- 7. EXCAVATE ALL AROUND THE EXISTING SUBSTRUCTURE.
- 8. DEMOLISH AND REMOVE THE EXISTING ABUTMENTS AND WINGWALLS.
 9. PREPARE SUBGRADE FOR INSTALLATION OF BOX CULVERT.
- 10. INSTALL PRECAST BOX CULVERT AND PRECAST CURTAIN WALLS.
- 11. CONSTRUCT PRECAST WINGWALL FOOTINGS AND PRECAST WINGWALL STEMS.
- 12. BACKFILL BEHIND THE BOX CULVERT AND WINGWALLS TO THE BOTTOM OF THE APPROACH SLAB ELEVATION.
- 13. INSTALL RIPRAP AND NATURAL STREAMBED MATERIAL AROUND THE WINGWALLS AND INSIDE THE BOX CULVERT, AS INDICATED.
- 14. REMOVE TEMPORARY DIVERSION PIPE AND COFFERDAM AND DIVERT WATER THROUGH THE PROPOSED BOX CULVERT.
- 15. INSTALL REINFORCING AND CONSTRUCT CAST—IN—PLACE CONCRETE SIDEWALK AND SAFETY CURB.
- 16. INSTALL PRECAST HIGHWAY GUARDRAIL TRANSITIONS AND S3-TL4 BRIDGE RAILING.
- 17. INSTALL REINFORCING AND CONSTRUCT CAST—IN—PLACE APPROACH SLABS.
 18. INSTALL SPRAY—APPLIED MEMBRANE WATERPROOFING AND PAVE PROTECTIVE
- COURSE ON BRIDGE.

 19. PERFORM FULL—DEPTH ROADWAY RECONSTRUCTION, GRADING AND ESTABLISH
- VEGETATION ON BOTH SIDES OF THE BRIDGE.
- 20. PLACE HMA BASE COURSE, INSTALL GUARDRAIL, PAVE WEARING COURSE AND COMPLETE LINE STRIPING.
- 21. REMOVE EROSION CONTROLS AND DETOUR SIGNAGE AND OPEN ROADWAY AND BRIDGE TO TRAFFIC.

CHAPTER 85 SECTION 35 REVIEW AND APPROVAL:

IN ACCORDANCE AND COMPLIANCE WITH THE REQUIREMENTS OF CHAPTER 85 SECTION 35 OF THE MASSACHUSETTS GENERAL LAWS, THE CONTRACTOR SHALL SUBMIT TO THE MASSACHUSETTS DEPARTMENT OF TRANSPORTATION ALL CONSTRUCTION DRAWINGS AND DESIGN CALCULATIONS THAT SHALL BE USED TO FABRICATE AND CONSTRUCT THE STRUCTURE DENOTED ON THESE PLANS FOR REVIEW AND APPROVAL. THIS APPROVAL SHALL CONSTITUTE THE FINAL APPROVAL AS STIPULATED BY CHAPTER 85 SECTION 35 OF THE MASSACHUSETTS GENERAL LAWS.

TRAFFIC DATA		
	ROADWAY OVER	ROADWAY UNDER
DESIGN YEAR	2040	
AVERAGE DAILY TRAFFIC - PRESENT	3660	
AVERAGE DAILY TRAFFIC - DESIGN YEAR	4465	
DESIGN HOURLY VOLUME	401	
DIRECTIONAL DISTRIBUTION	69% SB	X
TRUCK PERCENTAGE — AVERAGE DAY	6%	
TRUCK PERCENTAGE — PEAK HOUR	0.66%	
DESIGN SPEED	30 MPH	
DIRECTIONAL DESIGN HOURLY VOLUME	277	

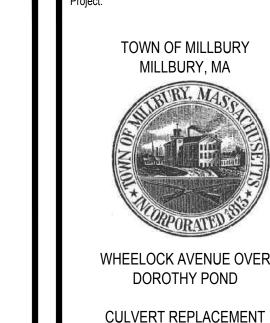
SEISMIC DESIGN CRITERIA	
DESIGN RETURN PERIOD:	1000
DESIGN SPECTRA	
As	0.128
SDs	0.285
SD1	0.156
SITE CLASS	D
SEISMIC DESIGN CATEGORY (SDC)	В

HYDRAULIC DESIGN DATA	
DRAINAGE AREA (SQ. MILES)	2.81
DESIGN FLOOD DISCHARGE (C.F.S.)	155
DESIGN FLOOD FREQUENCY (YEARS)	10
DESIGN FLOOD VELOCITY (F.P.S.)	4.38
DESIGN FLOOD ELEVATION (FEET, NAVD)	394.38
BASE (100—YEAR) FLOOD DATA	
BASE FLOOD DISCHARGE (C.F.S.)	565
BASE FLOOD ELEVATION (FEET, NAVD)	397.49
DESIGN AND CHECK SCOUR DATA	
DESIGN SCOUR FLOOD EVENT	25
RETURN FREQUENCY (YEARS)	20
DESIGN FLOOD ABUTMENT SCOUR DEPTH (FEET)	N/A
DESIGN FLOOD PIER SCOUR DEPTH (FEET)	N/A
CHECK SCOUR FLOOD EVENT	50
RETURN FREQUENCY (YEARS)	
CHECK FLOOD ABUTMENT SCOUR DEPTH (FEET)	N/A
CHECK FLOOD PIER SCOUR DEPTH (FEET)	N/A
FLOOD OF RECORD	
DISCHARGE (C.F.S.)	UNKNOWN
FREQUENCY (IF KNOWN, YEARS)	UNKNOWN
MAXIMUM ELEVATION (FEET, NAVD)	UNKNOWN
DATE (MM/YYYY)	UNKNOWN
HISTORY OF ICE FLOES	NONE
EVIDENCE OF SCOUR	MINOR*
AND EROSION	
* EVIDENCE OF SCOUR HOLE UNDER STRUCTU	RE.

* EVIDENCE OF SCOUR HOLE UNDER STRUCTURE. PROPOSED BOX CULVERT IS SCOUR RESISTANT.

TEMPORARY WATER CONTROL DESIGN DATA	_
DESIGN FLOOD DISCHARGE (C.F.S.)	40
DESIGN FLOOD FREQUENCY (YEARS)	2
DESIGN FLOOD VELOCITY (F.P.S.)	4.7
DESIGN FLOOD ELEVATION (FEET, NAVD) **	397.23

** CONTRACTOR MUST HAVE CORRESPONDENCE WITH DOROTHY POND DAM OWNERS THROUGHOUT THE CONSTRUCTION TO MAINTAIN A POND LEVEL OF 394.0 OR LOWER. THE TEMPORARY DESIGN FLOOD ELEVATION OF 397.23 IS AT THE UPSTREAM LOCATION OF THE TEMPORARY WATER CONTROL SYSTEM.

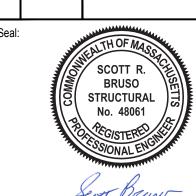


Weston & Sampson

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800.SAMPSON
www.westonandsampson.com

Consultants:

Re	visions:		
No	. Date	Description	



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Scale: AS NOTED

Date OCTOBER 9, 2024

Drawn By: YS

Reviewed By: CJW

Approved By: SRB

W&S Project No.: 2180493

Drawing Title:

GENERAL NOTES

Sheet Number:

S-2

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DISTRICT 3 BRIDGE ENGINEER DATE

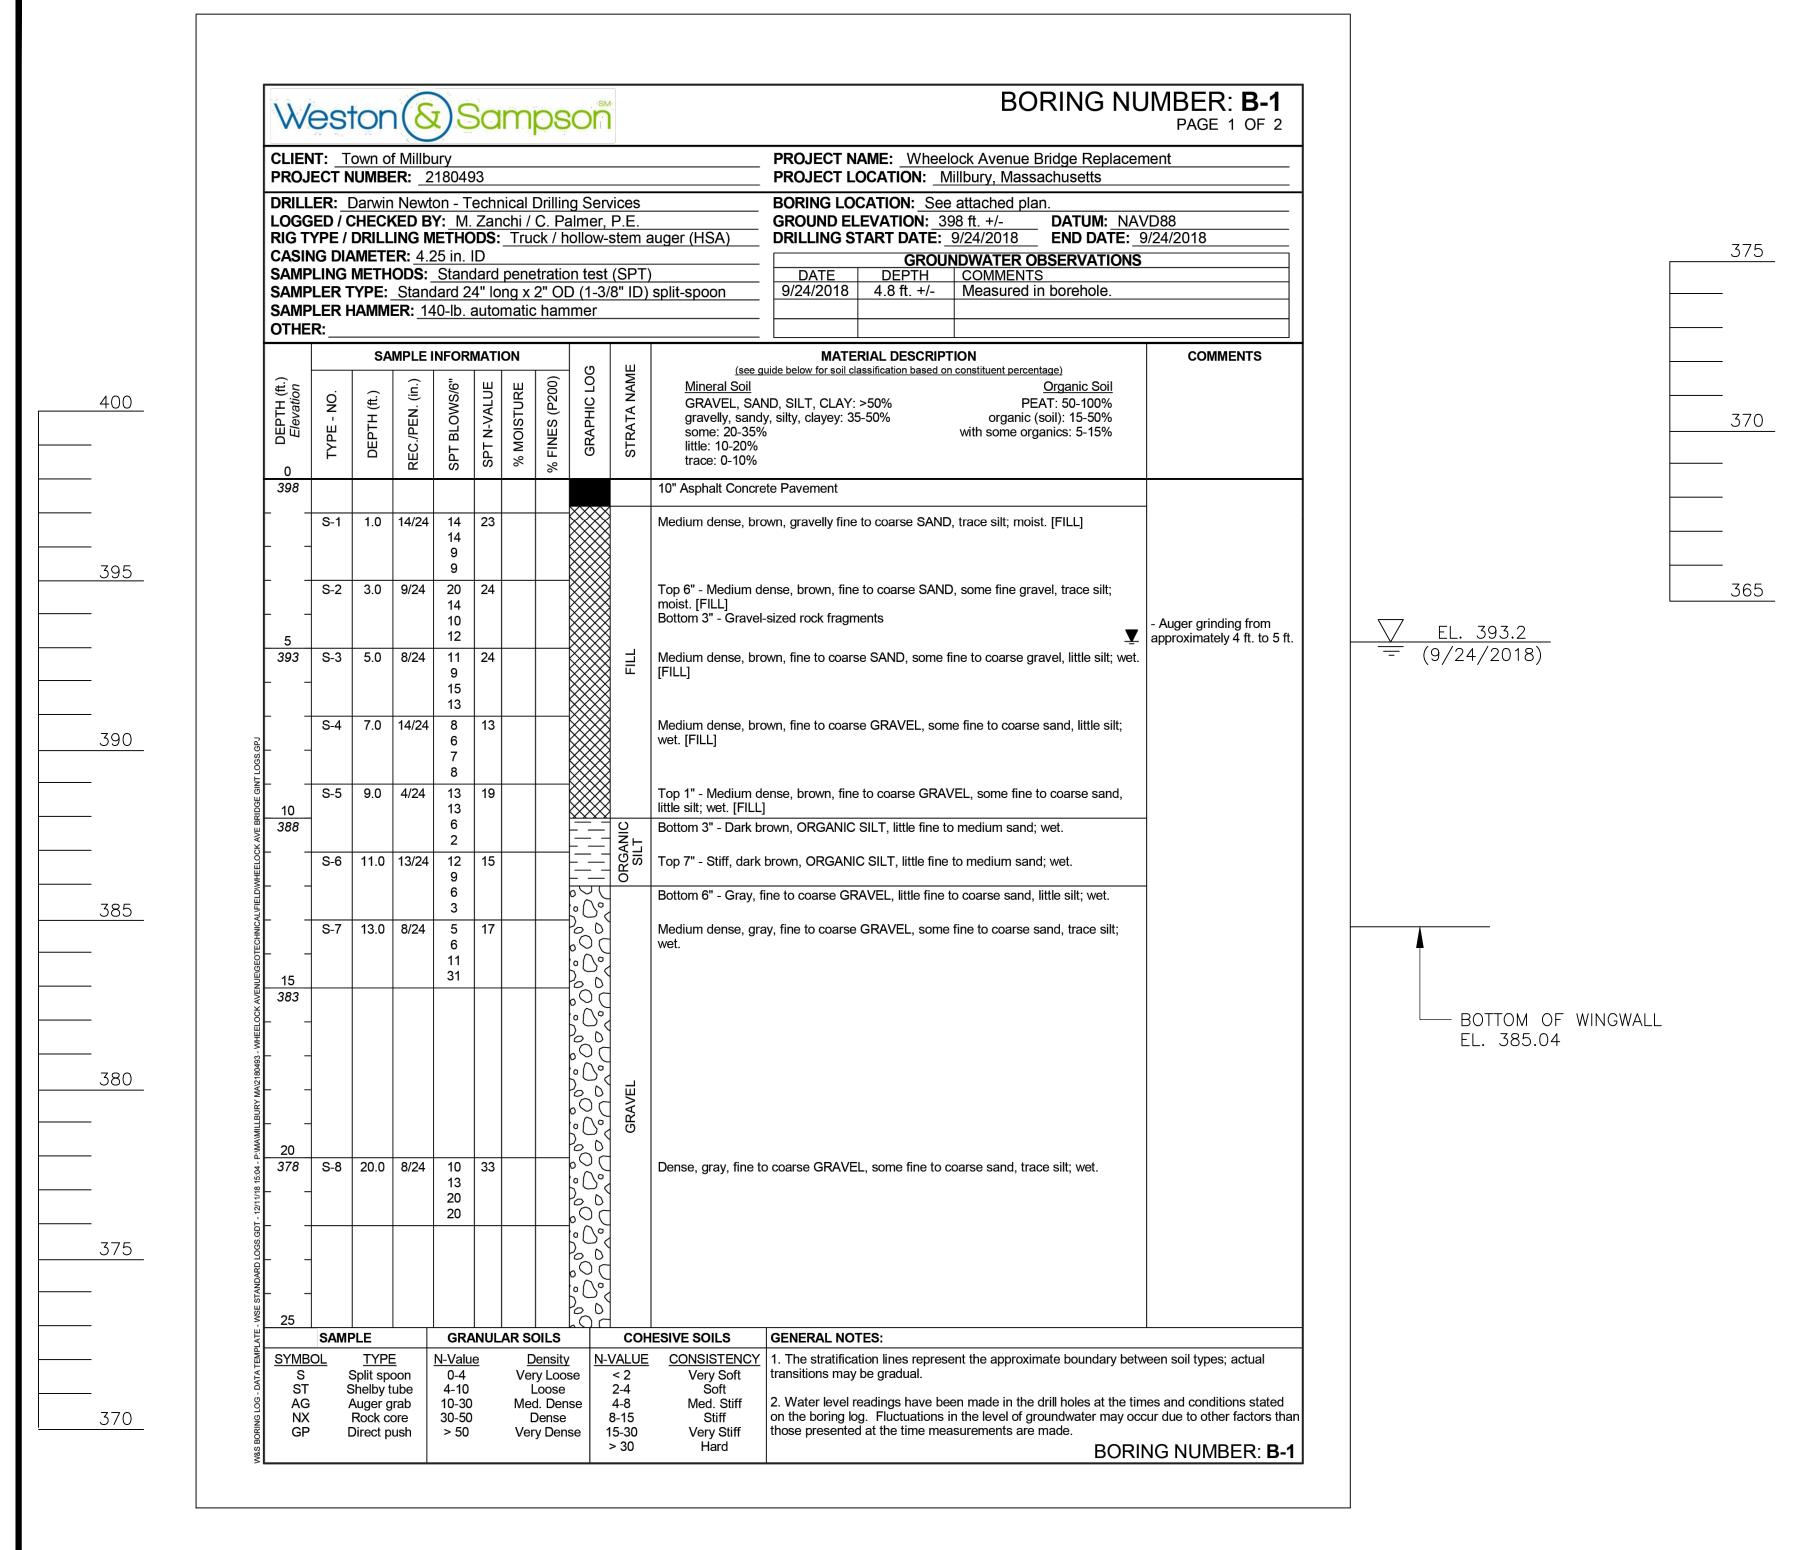
BRIDGE SHEET 2 OF 13 BRIDGE NO. M-22-022 (CPC)

Mohammed Nabulsi

5L STILLT 2 OT 13 BINDOLINO. IVI-22-022 (CFG)

COMMONWEALTH OF MASSACHUSETTS
MassDOT, Highway Division

CONCEPTUAL DESIGN IS ACCEPTABLE TO MASSDOT FOR CONTRACTING



Weston Sampson CLIENT: Town of Millbury										PF	ROJECT NAME:	Wheeloo	k Avenue	Bridge R	Replacem	nent			
	ECT N				3				PROJECT NAME: Wheelock Avenue Bridge Replacement PROJECT LOCATION: Millbury, Massachusetts MATERIAL DESCRIPTION COMMENT										
		SAN				NFORI	MATIC	ON		ပ္ခ	ų l	<u>(see guide k</u>	MATERIAL DE pelow for soil classification			ntage)		СОММ	ENTS
DEPTH (ft.)	TYPE - NO.	DЕРТН (ft.)	REC./PEN. (in.)	SPT BLOWS/6"	SPT N-VALUE	% MOISTURE	% FINES (P200)	GRAPHIC LOG	STRATA NAME	Mineral Soil GRAVEL, SAND, S gravelly, sandy, silt some: 20-35% little: 10-20% trace: 0-10%		١		Organic EAT: 50-10 (soil): 15-9 ganics: 5-7	00% 50%				
373 	S-9	25.0	6/24	22 14 29 32	43					Dense, gray, fine to coa	arse GRAVEL, little f	fine to coars	se sand, trac	e silt; wet.		- Possible bou			
30 368	S-10	30.0	14/24		116				VEL	Very dense, gray, fine t	o coarse GRAVEL, s	some fine t	o coarse sar	ıd, little silt	; wet.	- Possible bou	ılder at 30		
				73 43 27												based on aug	er grinding		
										End of boring at 32 ft.									
SYMB		TYPE		N-Value			ensity		ALUE	CONSISTENCY 1. 1	NERAL NOTES: The stratification line		the approxi	mate bour	ndary betw	een soil types;	actual		
SYMB S ST AG NX GP	OL SI SI AI		on lbe ab re		<u>e</u>	D Ver L Med		e		CONSISTENCY Very Soft Soft Med. Stiff Stiff On		lual. have been tuations in	made in the	drill holes	at the tim	nes and condition	ons state		

BORING/PROBE NOTES:

- 1. LOCATION OF BORING SHOWN ON THE PLAN THUS $igoplus_{ exttt{RR}}$
- 2. LOCATION OF PROBES SHOWN ON THE PLAN THUS -P-1, P-2, ...
- 3. BORINGS AND PROBES ARE TAKEN FOR PURPOSE OF DESIGN AND SHOW CONDITIONS AT BORING POINTS AND PROBE POINTS ONLY, BUT DO NOT NECESSARILY SHOW THE NATURE OF THE MATERIALS TO BE ENCOUNTERED DURING CONSTRUCTION.
- 4. WATER LEVELS SHOWN ON THE BORING LOGS WERE OBSERVED AT THE TIME OF TAKING BORINGS AND DO NOT NECESSARILY SHOW THE TRUE GROUND WATER LEVEL.
- 5. FIGURES IN COLUMNS INDICATE NUMBER OF BLOWS REQUIRED TO DRIVE A 2" I.D. SPLIT SPOON SAMPLER 24" USING A 140 POUND WEIGHT FALLING 30".
- 6. BORING SAMPLES ARE STORED AT A STORAGE FACILITY LOCATED ON ROUTE 114 (219 WINTHROP AVE.) LAWRENCE, MA. THE CONTRACTOR MAY EXAMINE THE SOIL AND SAMPLES BY CONTACTING THE MASSDOT GEOTECHNICAL SECTION AT 10 PARK PLAZA, BOSTON, MA.
- 7. ALL BORINGS WERE MADE IN SEPTEMBER 2018. ALL PROBES WERE MADE IN SEPTEMBER 2018.
- 8. BORINGS AND PROBES WERE MADE BY TECHNICAL DRILLING SERVICES. (2 PETER DRIVE STERLING, MA 01564)
- 9. THE NORTH AMERICAN VERTICAL DATUM (NAVD) OF 1988 IS USED THROUGHOUT.

COMMONWEALTH OF MASSACHUSETTS MassDOT, Highway Division CONCEPTUAL DESIGN IS ACCEPTABLE TO MASSDOT FOR CONTRACTING Mohammed Nabulsi

DISTRICT 3 BRIDGE ENGINEER

BRIDGE SHEET 3 OF 13 BRIDGE NO. M-22-022 (CPC)

DATE

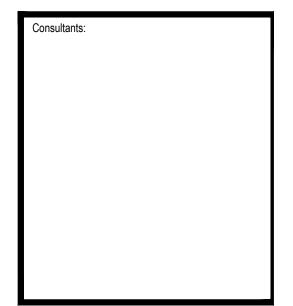
TOWN OF MILLBURY MILLBURY, MA WHEELOCK AVENUE OVER

Weston & Sampson

DOROTHY POND

CULVERT REPLACEMENT

Weston & Sampson Engineers, Inc. 100 Foxborough Boulevard, Suite 250 Foxborough, MA 02035 978.532.1900 www.westonandsampson.com



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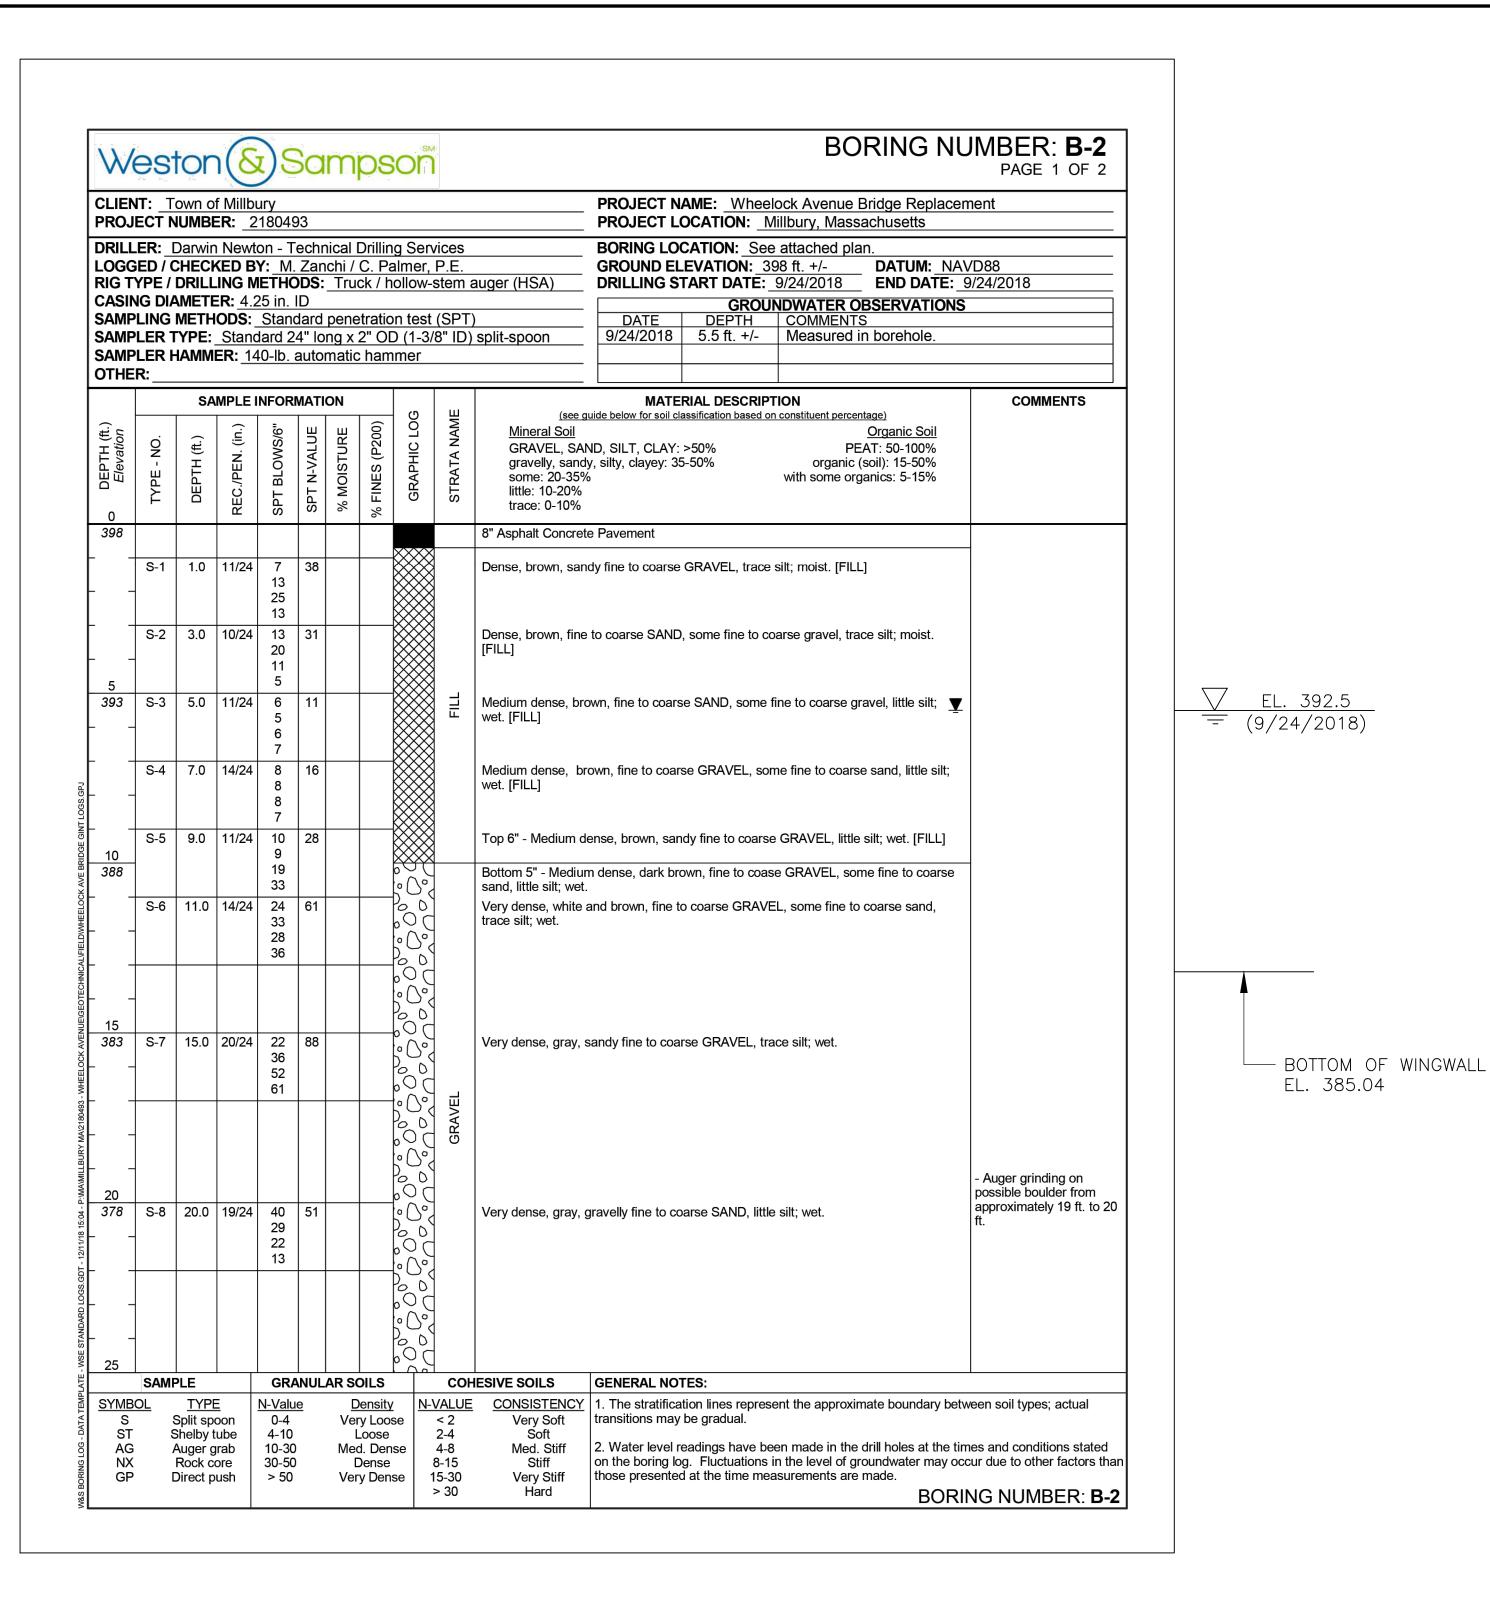
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Drawn By: CJW Reviewed By: SRB Approved By:

W&S Project No.: 2180493

BORING LOGS

Sheet Number:



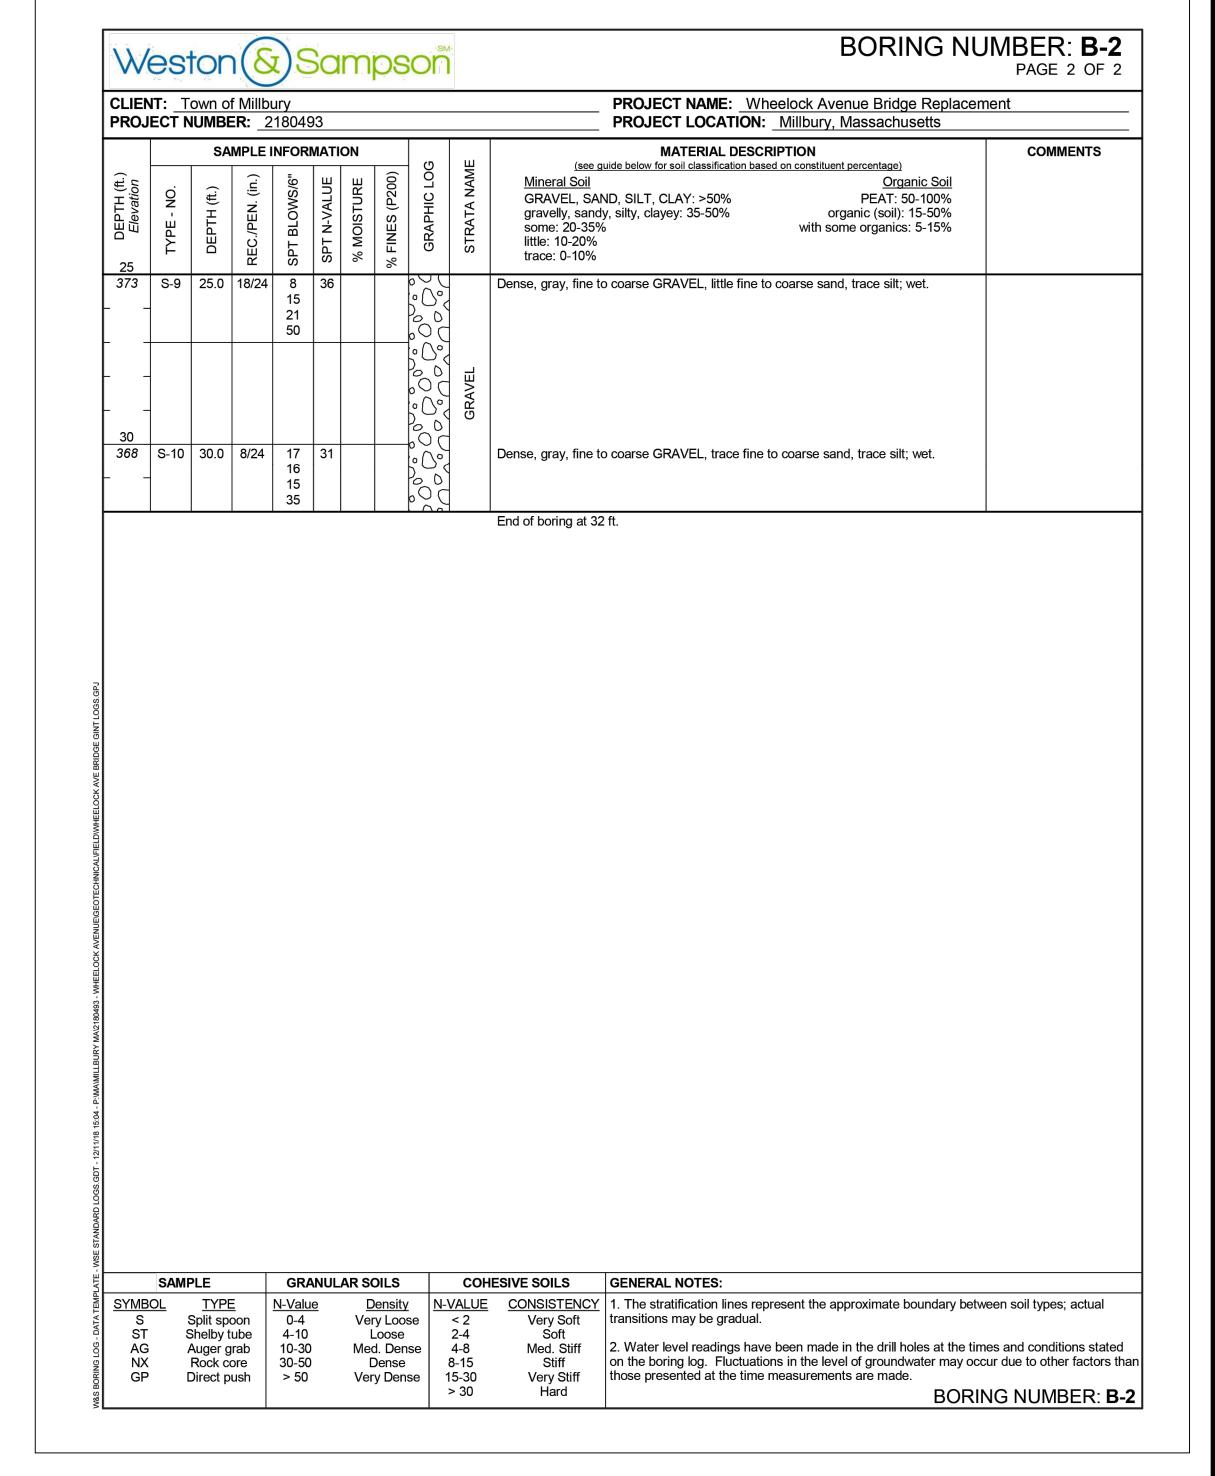
400

390

380

375

370



375

370

365

EL. 385.04

TOWN OF MILLBURY MILLBURY, MA WHEELOCK AVENUE OVER

Weston & Sampson

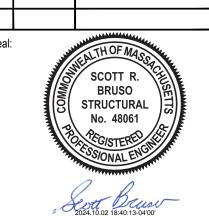
DOROTHY POND

CULVERT REPLACEMENT

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W&S Project No.: 2180493

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BORING LOGS

Sheet Number:

COMMONWEALTH OF MASSACHUSETTS MassDOT, Highway Division CONCEPTUAL DESIGN IS ACCEPTABLE TO MASSDOT FOR CONTRACTING Mohammed Nabulsi

DISTRICT 3 BRIDGE ENGINEER

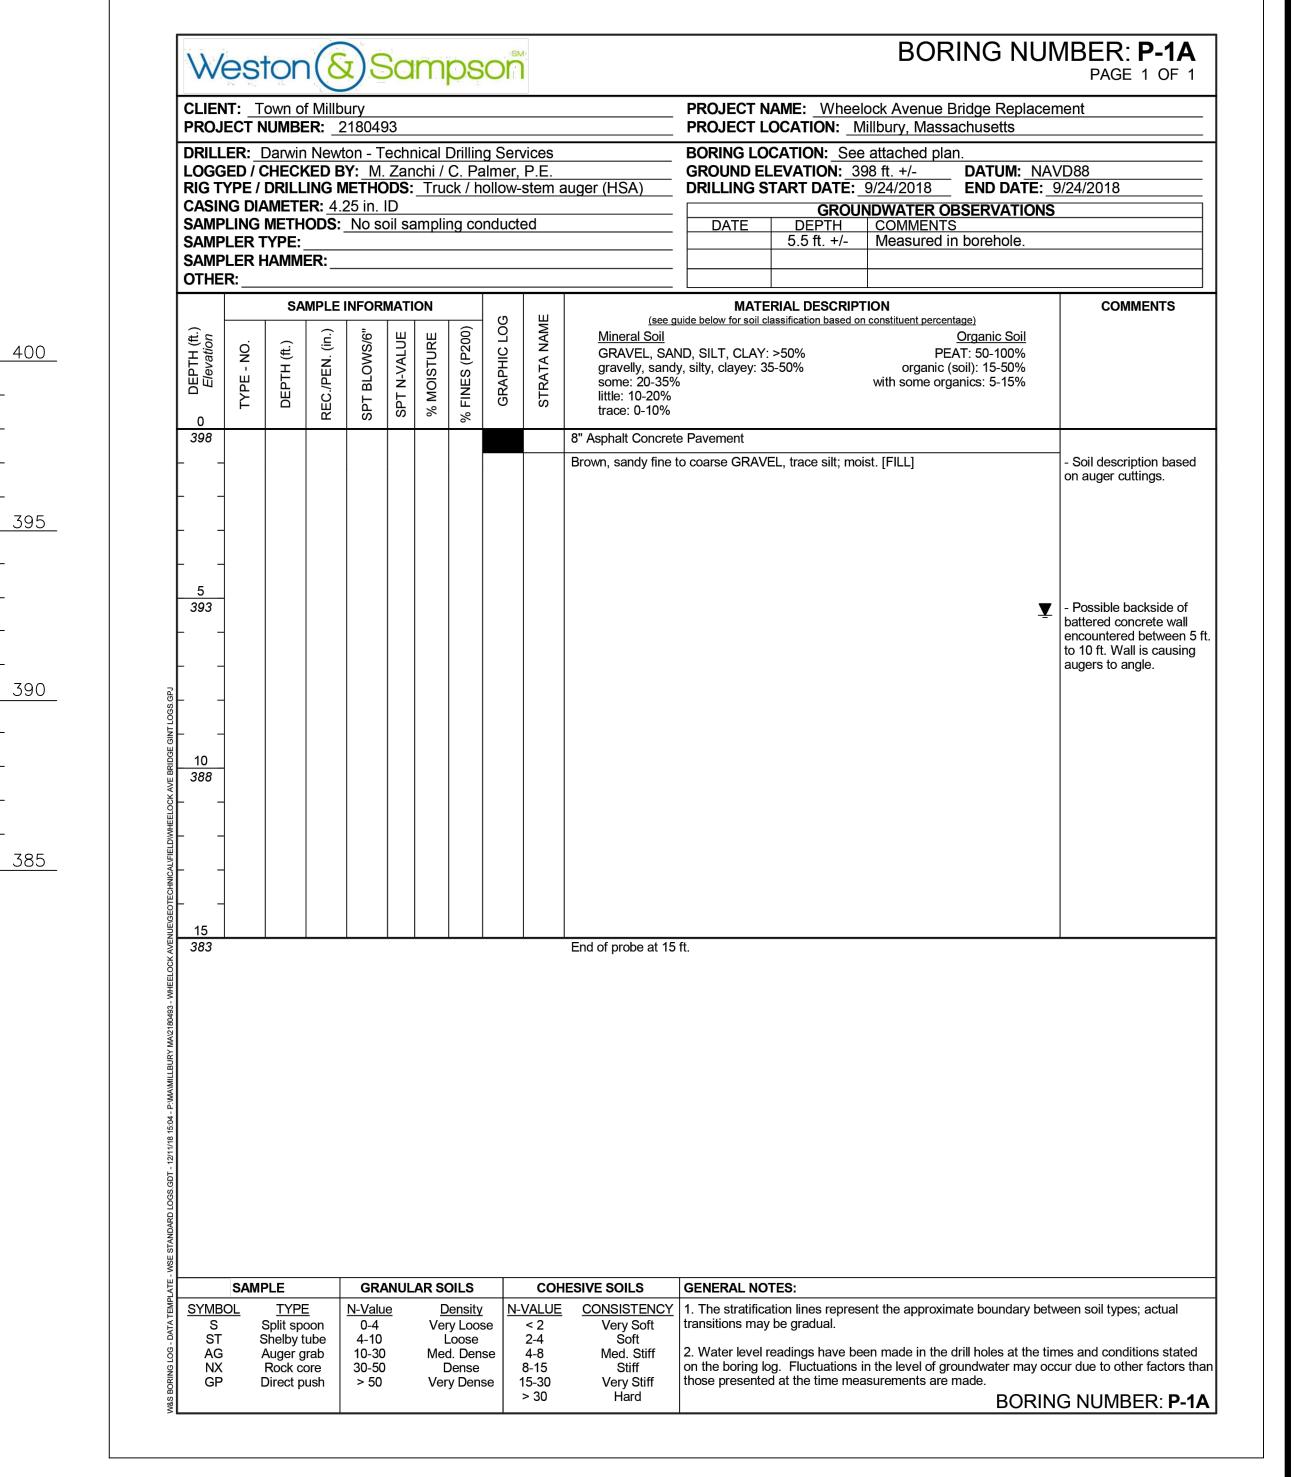
BRIDGE SHEET 4 OF 13 BRIDGE NO. M-22-022 (CPC)

DATE

	es [†]	ton	(8	J)S	Sar	mķ	280					DOKING N	UMBER: P-1 PAGE 1 OF 1			
CLIENT: Town of Millbury PROJECT NUMBER: 2180493										PROJECT NAME: _Wheelock Avenue Bridge Replacement PROJECT LOCATION: _Millbury, Massachusetts						
RILLER: Darwin Newton - Technical Drilling Services OGGED / CHECKED BY: M. Zanchi / C. Palmer, P.E.										BORING LO	CATION: See	attached plan.	AVD88			
IG T\ ASIN	YPE / IG DI <i>A</i>	DRILLI METE	NG M R: 4.2	ETHO 25 in. I	DS :_ D	Truc	k / hol	llow-st	em auger (HSA)	GROUND ELEVATION: 398 ft. +/- DRILLING START DATE: 9/24/2018 GROUNDWATER OBSERVATIONS DATUM: NAVD88 END DATE: 9/24/2018						
AMPI	LER T	_			oil sar	<u>nplin</u>	ig con	ducted	<u> </u>	DATE	DEPTH 5.5 ft. +/-	COMMENTS Measured in borehole.				
THE		IAMME	:R:			<u> </u>										
,		SAN		NFORM		Т	<u></u>	90	□ (see		RIAL DESCRIPT assification based or	constituent percentage)	COMMENTS			
6 Elevation	TYPE - NO.	DEPTH (ft.)	REC./PEN. (in.)	SPT BLOWS/6"	SPT N-VALUE	% MOISTURE	% FINES (P200)	GRAPHIC LOG				Organic Soil PEAT: 50-100% organic (soil): 15-50% with some organics: 5-15%				
98									8" Asphalt Concre			-4 [FILL]	Cail description beard			
									Brown, sandy fine	to coarse GRAV	±L, trace siit; moi	si. [FILL]	- Soil description based on auger cuttings.			
5 93 –												_	<u>z</u>			
-																
									End of probe at 9	ft.						
YMBO	SAMF	PLE TYPE		GRA N-Value		AR SO	DILS ensity	N-VA	COHESIVE SOILS ALUE CONSISTENCY	GENERAL NO		ent the approximate boundary be	tween soil types; actual			

400

390

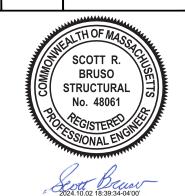


TOWN OF MILLBURY MILLBURY, MA WHEELOCK AVENUE OVER DOROTHY POND CULVERT REPLACEMENT Weston & Sampson Engineers, Inc. 100 Foxborough Boulevard, Suite 250 Foxborough, MA 02035

978.532.1900 800.SAMPSON www.westonandsampson.com

Consultants:

No. Date Description



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BORING LOGS

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COMMONWEALTH OF MASSACHUSETTS MassDOT, Highway Division CONCEPTUAL DESIGN IS ACCEPTABLE TO MASSDOT FOR CONTRACTING Mohammed Nabulsi DATE

DISTRICT 3 BRIDGE ENGINEER

BRIDGE SHEET 5 OF 13 BRIDGE NO. M-22-022 (CPC)

BORING NUMBER: P-2 PAGE 1 OF 1 PROJECT NAME: Wheelock Avenue Bridge Replacement CLIENT: Town of Millbury PROJECT LOCATION: Millbury, Massachusetts PROJECT NUMBER: 2180493 DRILLER: Darwin Newton - Technical Drilling Services BORING LOCATION: See attached plan.
 GROUND ELEVATION: 398 ft. +/ DATUM: NAVD88

 DRILLING START DATE: 9/24/2018
 END DATE: 9/24/2018
 LOGGED / CHECKED BY: M. Zanchi / C. Palmer, P.E. RIG TYPE / DRILLING METHODS: Truck / hollow-stem auger (HSA) CASING DIAMETER: 4.25 in. ID DEPTH COMMENTS
5.5 ft. +/- Measured in borehole. SAMPLING METHODS: No soil sampling conducted SAMPLER TYPE: SAMPLER HAMMER: OTHER: COMMENTS SAMPLE INFORMATION MATERIAL DESCRIPTION (see guide below for soil classification based on constituent percentage) Mineral Soil Organic Soil GRAVEL, SAND, SILT, CLAY: >50% PEAT: 50-100% gravelly, sandy, silty, clayey: 35-50% organic (soil): 15-50% some: 20-35% with some organics: 5-15% little: 10-20% trace: 0-10% 8" Asphalt Concrete Pavement Brown, sandy fine to coarse GRAVEL, trace silt; moist. [FILL] Soil description based on auger cuttings. Possible Stone Block - Auger through 10 in. - Fragment of stone block recovered from auger plug; appears to be flat on top and thick stone block from 5 ft bottom bottom side of stone block End of probe at 5.8 ft. at 5.8 ft. **GRANULAR SOILS** COHESIVE SOILS GENERAL NOTES: SAMPLE N-VALUE CONSISTENCY 1. The stratification lines represent the approximate boundary between soil types; actual N-Value transitions may be gradual. Split spoon Very Loose < 2 Very Soft 4-10 Shelby tube Loose AG NX GP 2. Water level readings have been made in the drill holes at the times and conditions stated Auger grab 10-30 Med. Dense Med. Stiff on the boring log. Fluctuations in the level of groundwater may occur due to other factors than Rock core 30-50 8-15 Stiff Dense 15-30 > 30 Direct push > 50 Very Dense Very Stiff those presented at the time measurements are made. Hard BORING NUMBER: P-2

400

390

LOGG RIG T CASIN SAMP SAMP	ED / C YPE / I IG DIA LING I LER T LER H	METER METHO	ED BY NG M R: <u>4.2</u> DS: _	Y: M. ETHC 25 in. I No so	Zan DS: D oil sa	ichi / _Trud amplir	C. Pal ck / ho ng con	mer, llow- iducte	P.E. stem a	auger (HSA)	BORING LOCATION: See attached plan. GROUND ELEVATION: 398 ft. +/- DRILLING START DATE: 9/24/2018 GROUNDWATER OBSERVATION: DATE DEPTH COMMENTS 5.5 ft. +/- Measured in borehole.	9/24/2018
& DEPTH (ft.)	TYPE - NO.		REC./PEN. (in.) Id	NFORI9/S/MOTIB LdS	SPT N-VALUE	% MOISTURE %	% FINES (P200)	GRAPHIC LOG	STRATA NAME	Mineral Soil GRAVEL, SAI	· ·	COMMENTS
											Ţ	on auger cuttings.
NDARD LOGS.GDT - 12/11/18 15:04 - P:\MA\MILBURY MA\Z180493 - WHEELOCK AVENUE\GEOTECHNICAL\FIELD\WHEELOCK												
DATA TEMPLATE - WSE STAN S		TYPE Split spoo	n -	GRA N-Valu 0-4 4-10		Ver	OILS ensity y Loose	∍ ̄	COH VALUE < 2 2-4	ESIVE SOILS CONSISTENCY Very Soft Soft	GENERAL NOTES: 1. The stratification lines represent the approximate boundary be transitions may be gradual.	tween soil types; actual

400

395

390

TOWN OF MILLBURY MILLBURY, MA WHEELOCK AVENUE OVER DOROTHY POND CULVERT REPLACEMENT Weston & Sampson Engineers, Inc. 100 Foxborough Boulevard, Suite 250 Foxborough, MA 02035 978.532.1900 www.westonandsampson.com Consultants:

Description

SCOTT R. BRUSO STRUCTURAL

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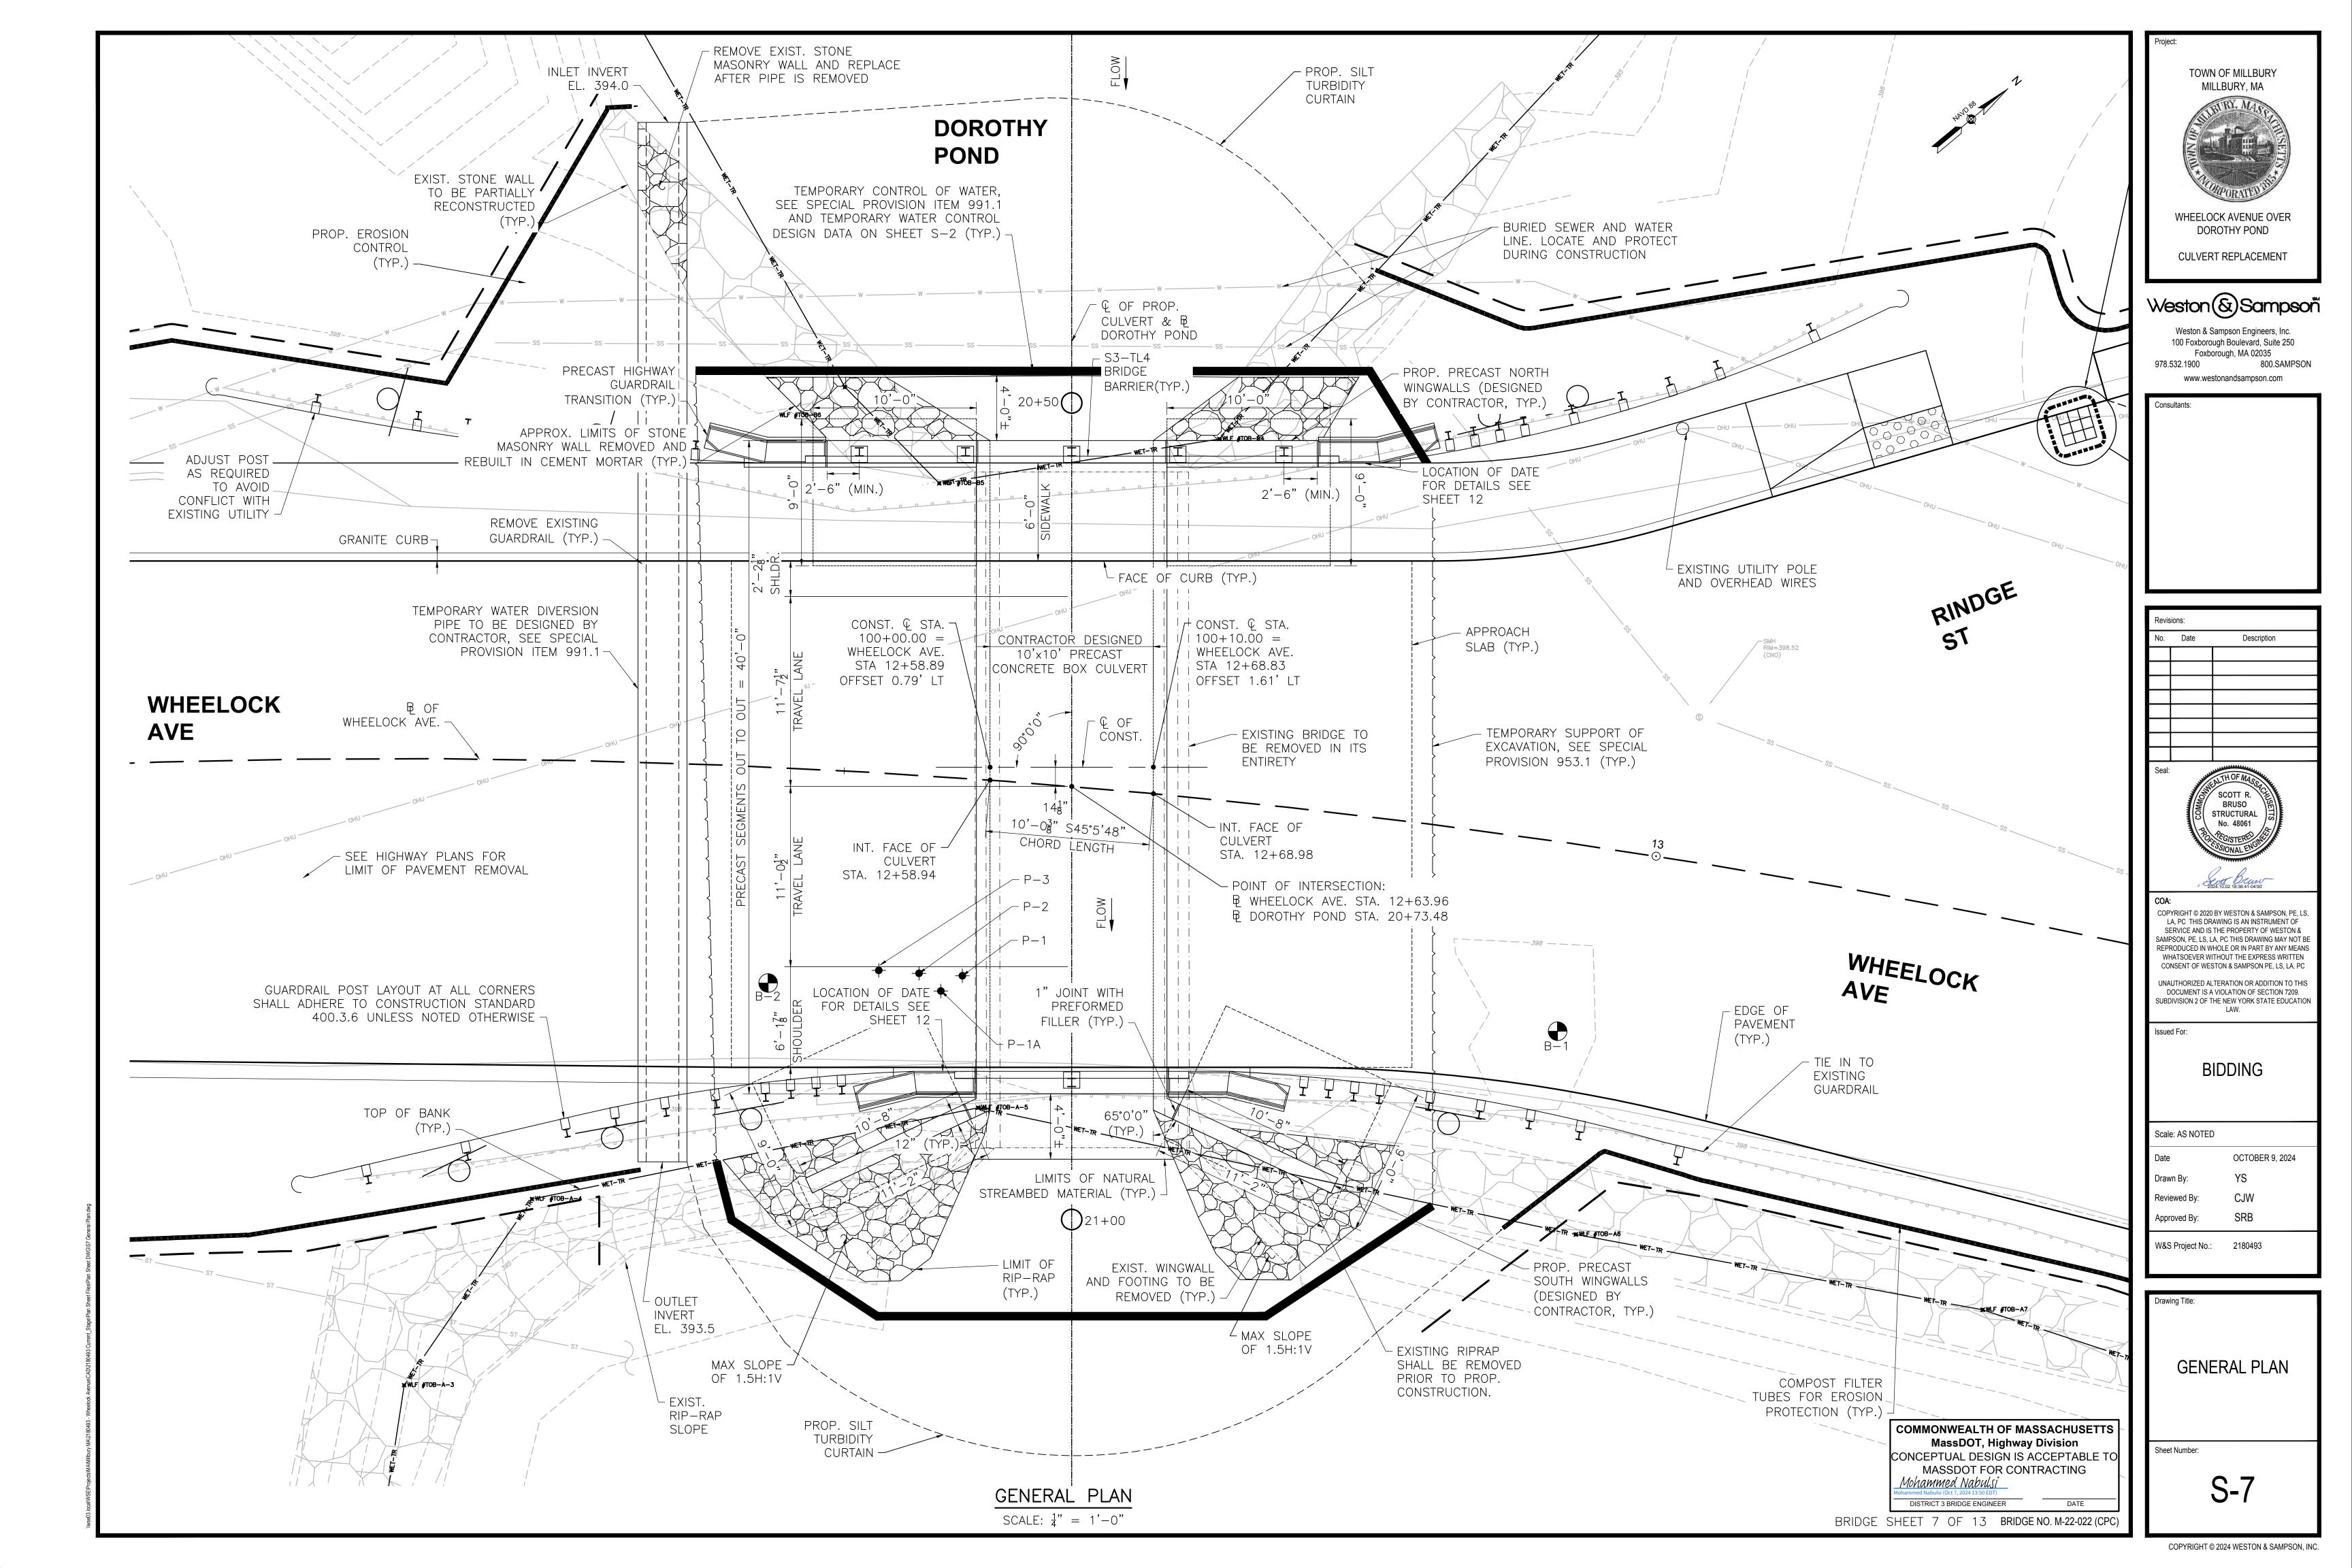
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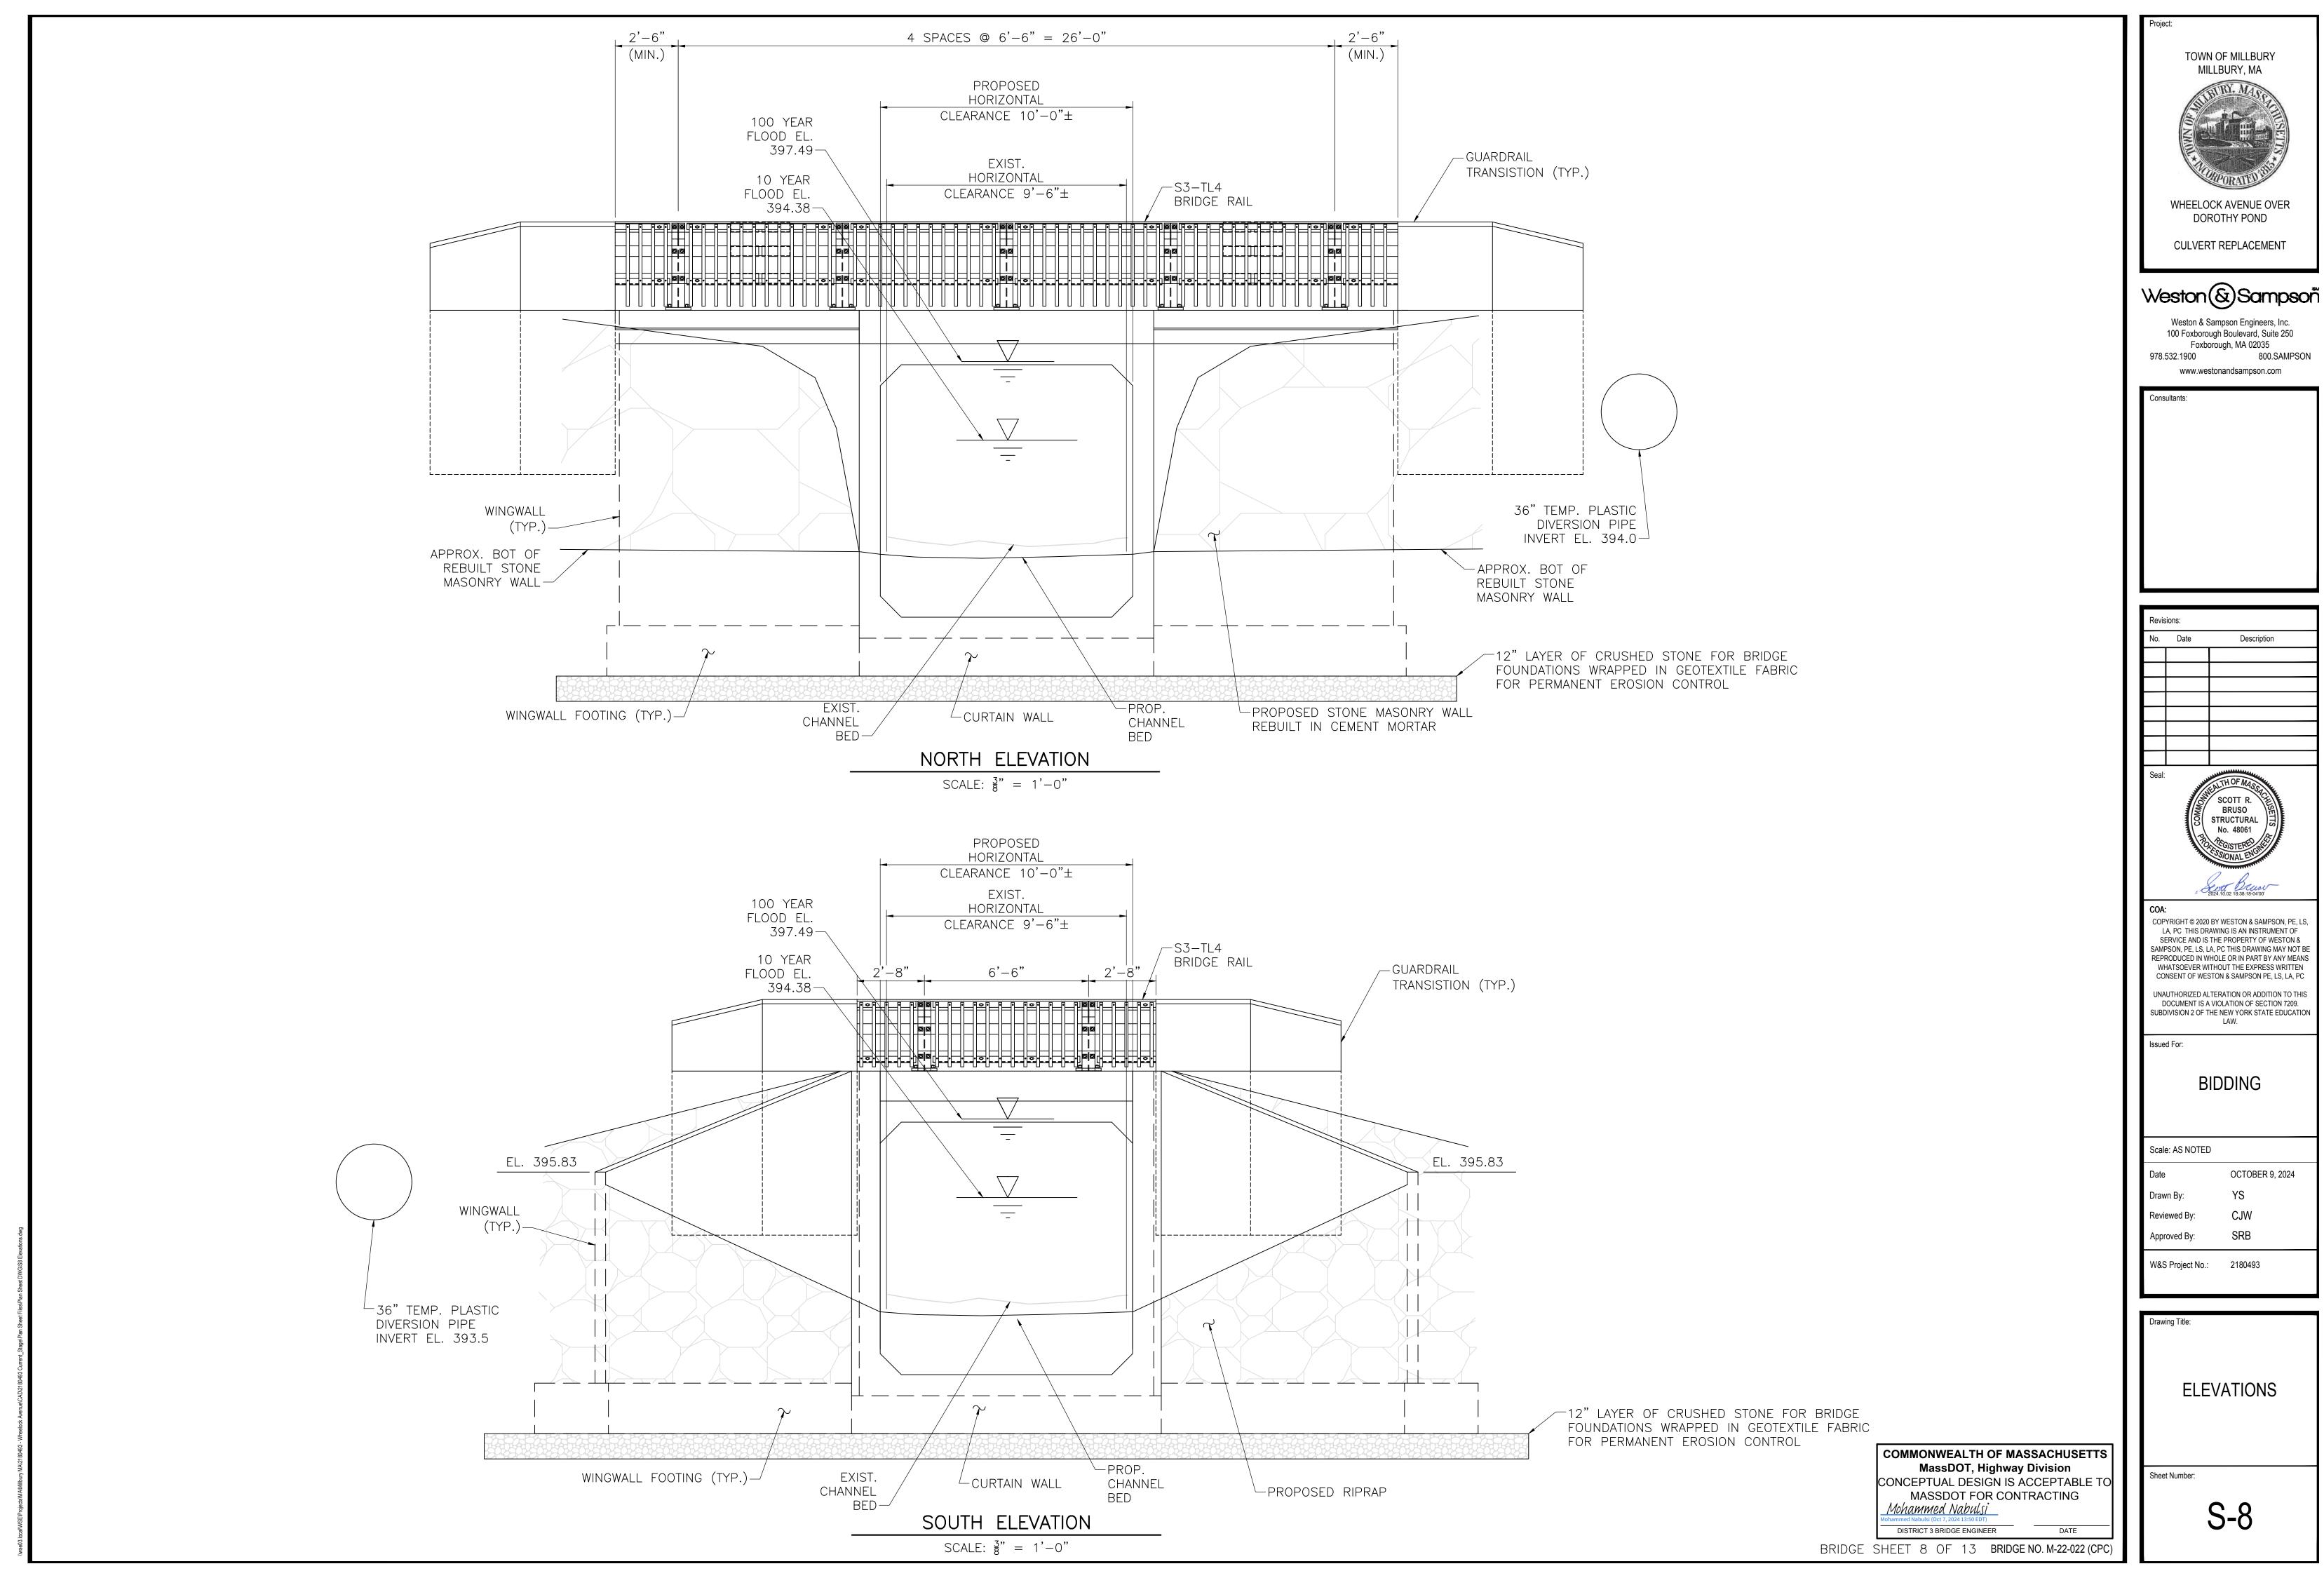
BORING LOGS

Sheet Number:

COMMONWEALTH OF MASSACHUSETTS MassDOT, Highway Division CONCEPTUAL DESIGN IS ACCEPTABLE TO MASSDOT FOR CONTRACTING Mohammed Nabulsi DISTRICT 3 BRIDGE ENGINEER DATE

BRIDGE SHEET 6 OF 13 BRIDGE NO. M-22-022 (CPC)



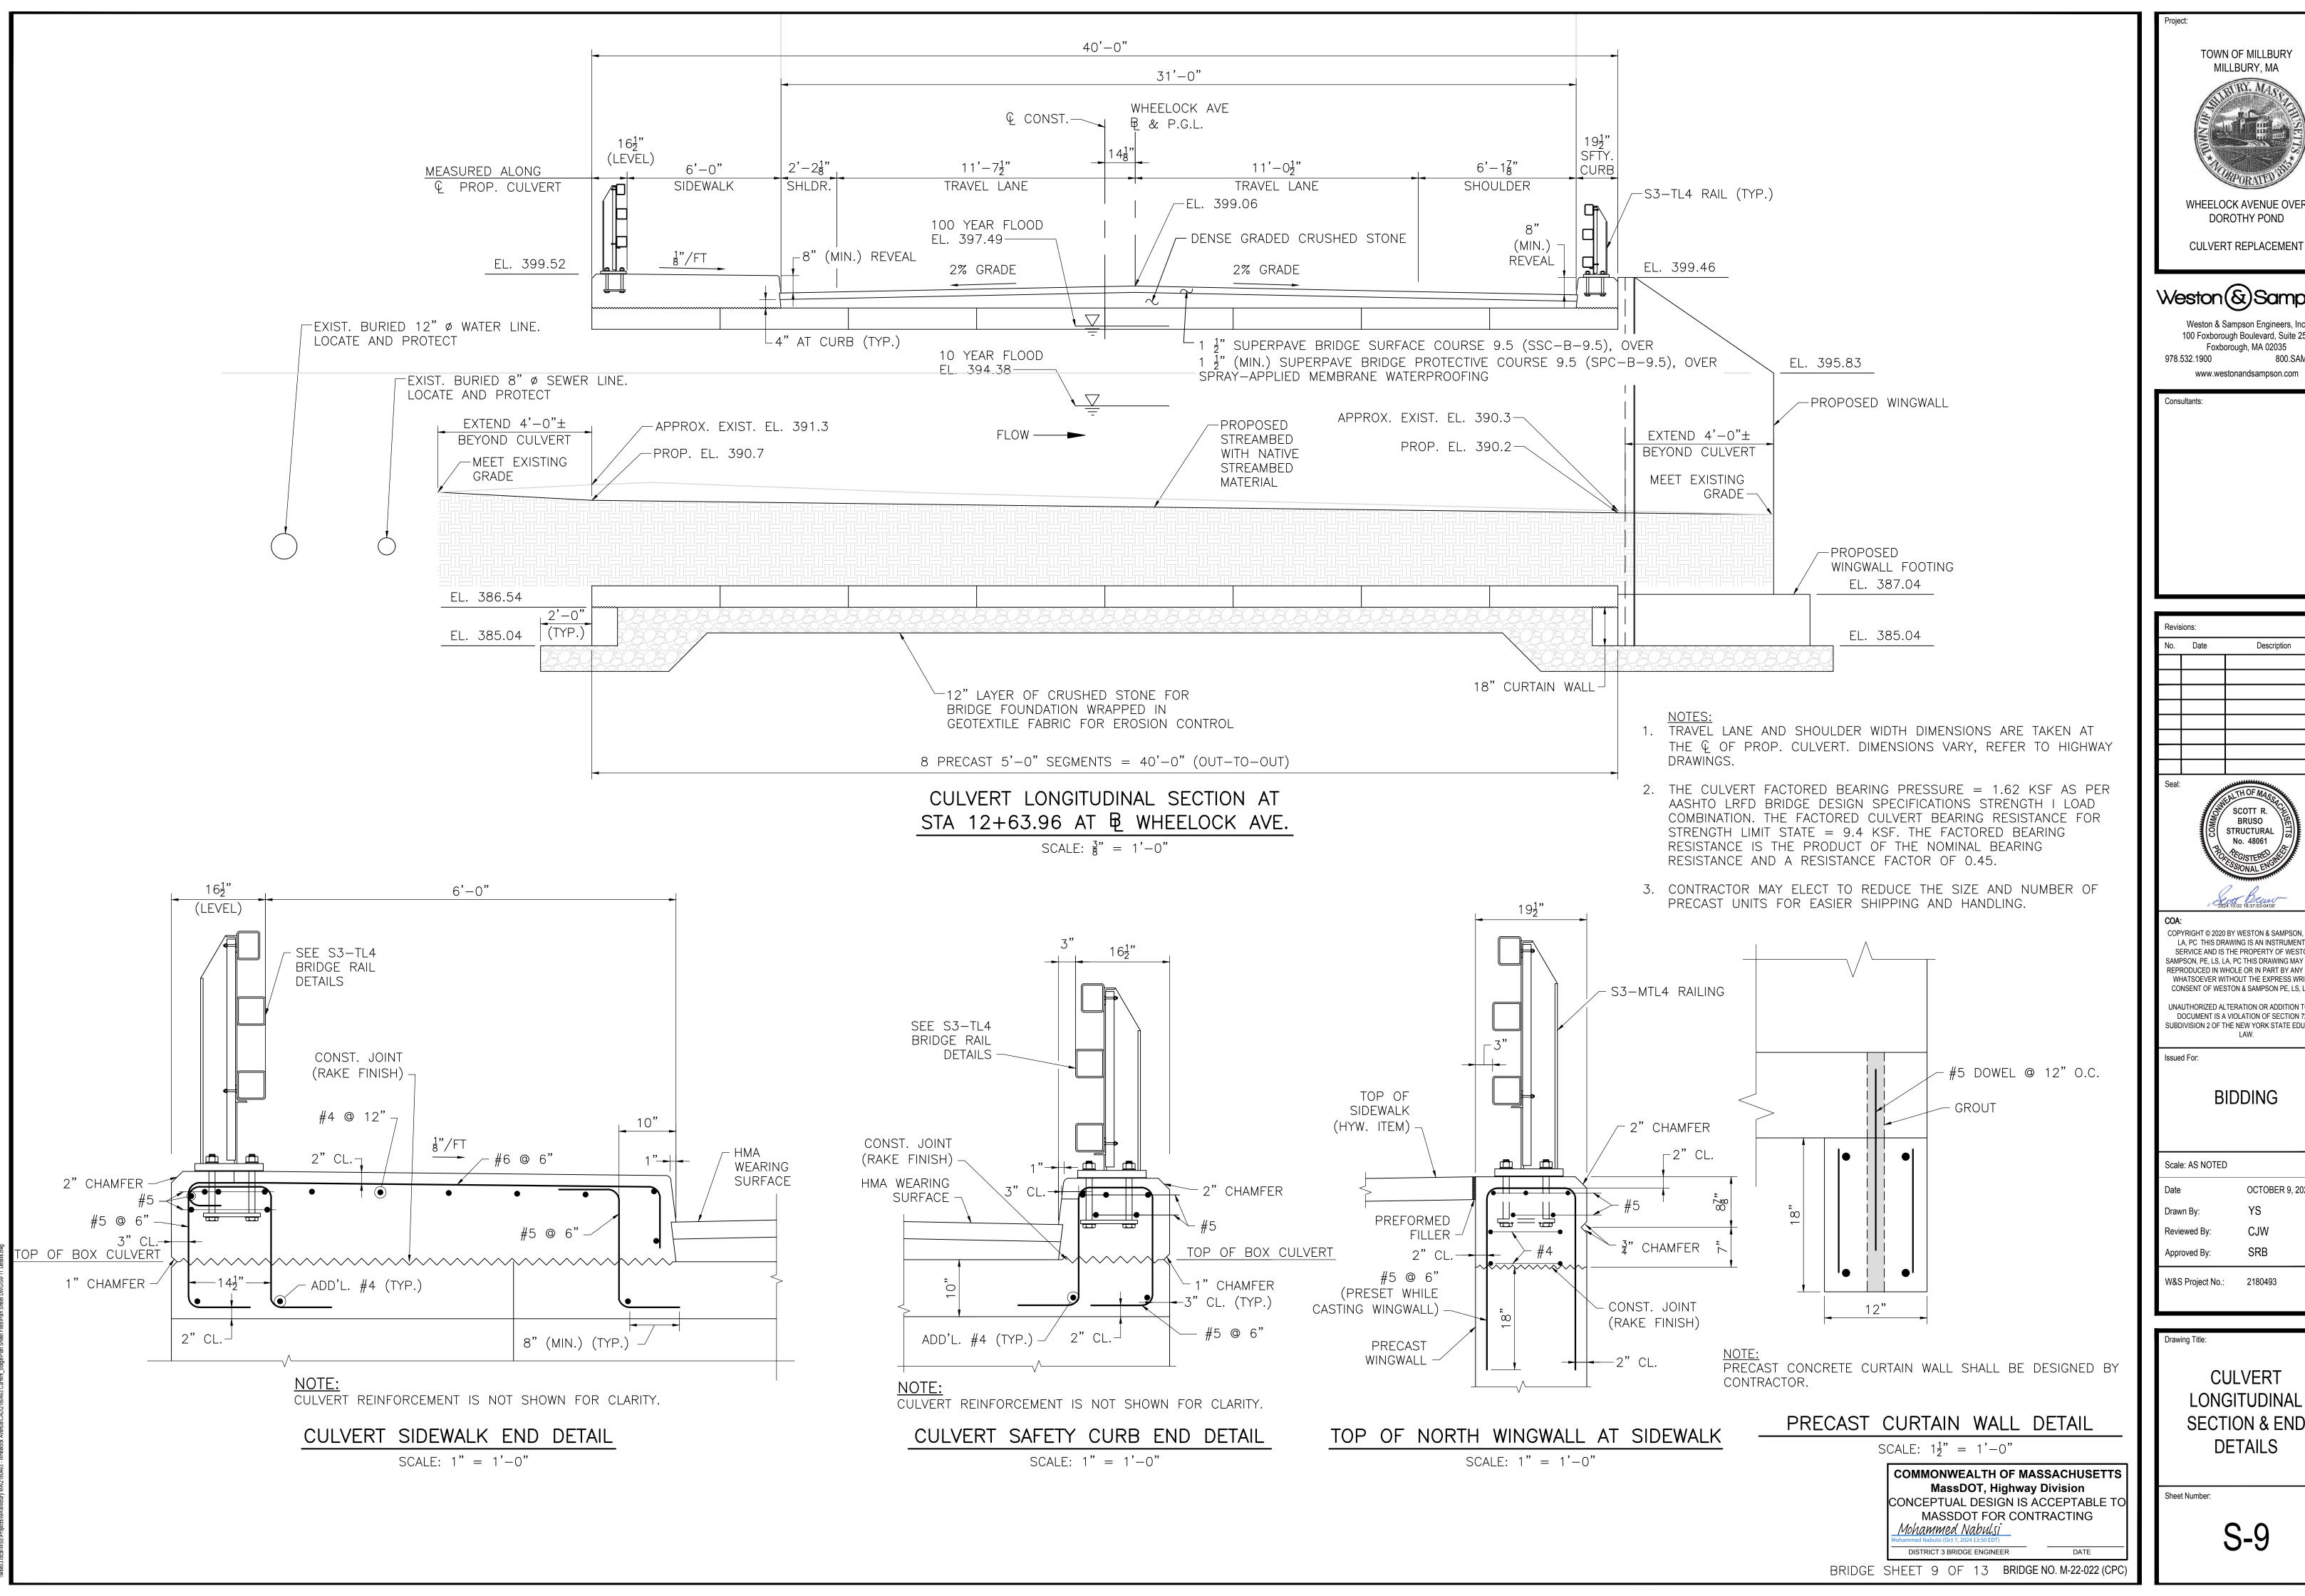


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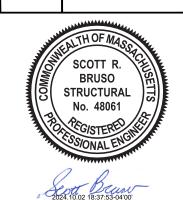


TOWN OF MILLBURY MILLBURY, MA WHEELOCK AVENUE OVER

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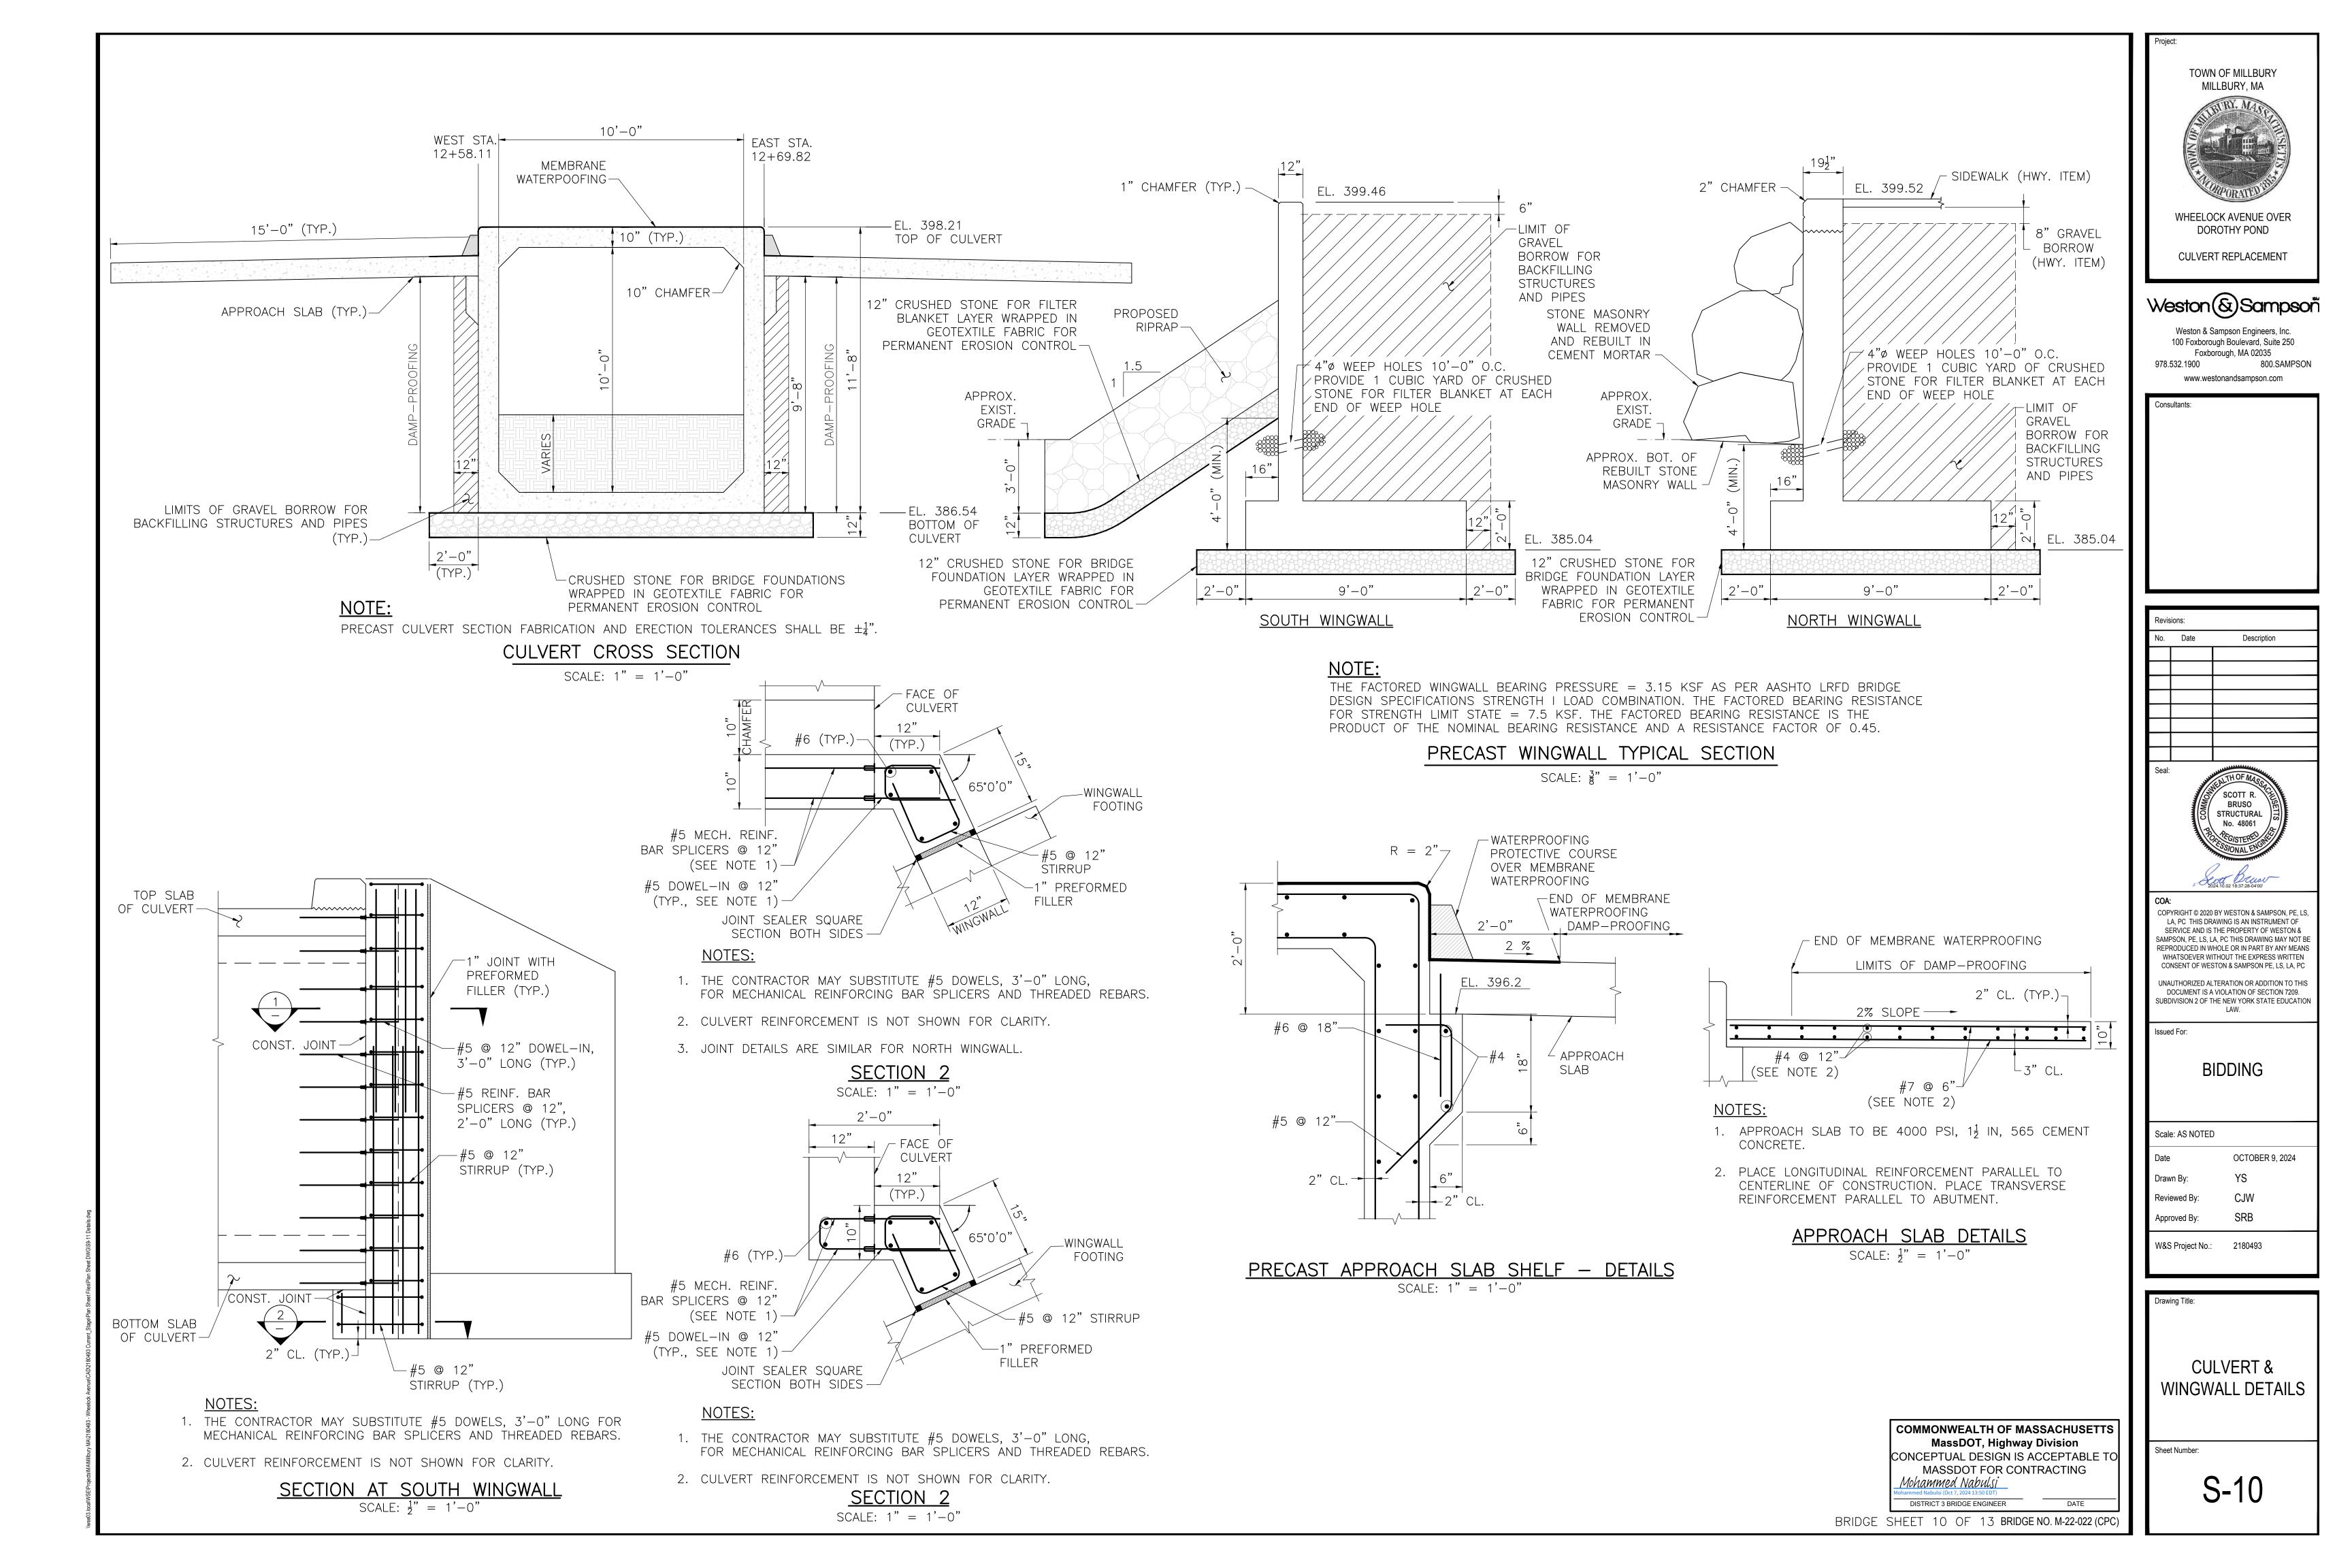
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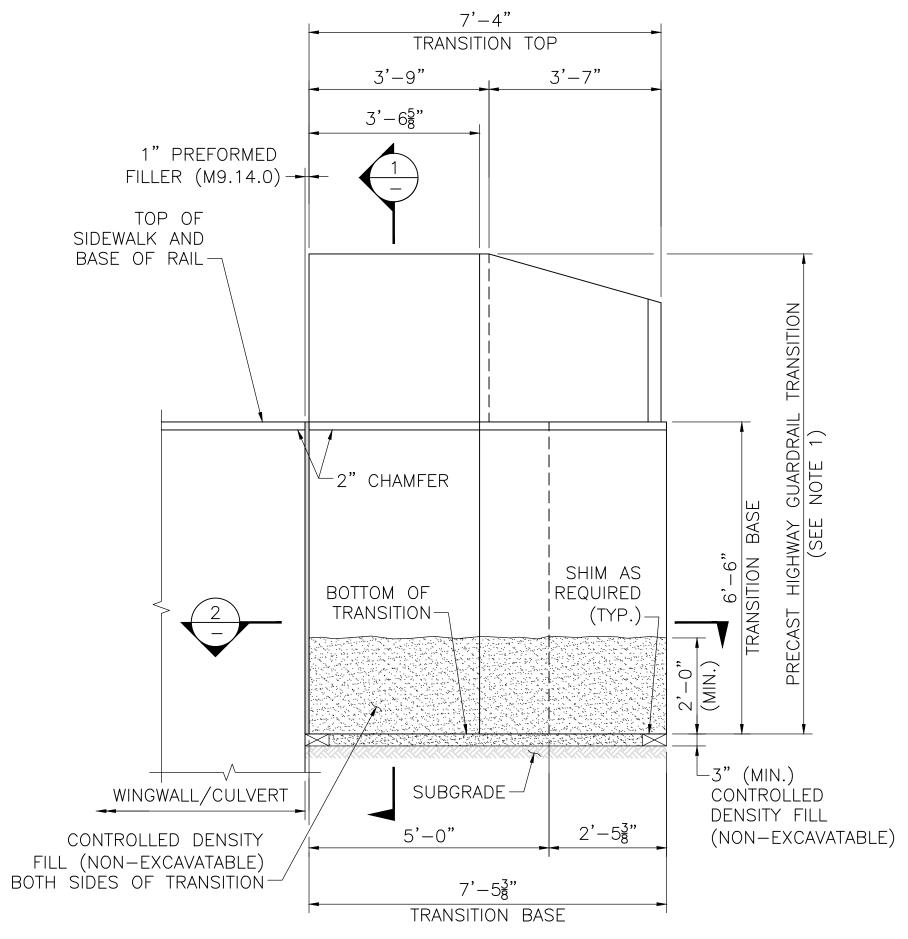
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OCTOBER 9, 2024 CJW

W&S Project No.: 2180493

CULVERT LONGITUDINAL **SECTION & END**



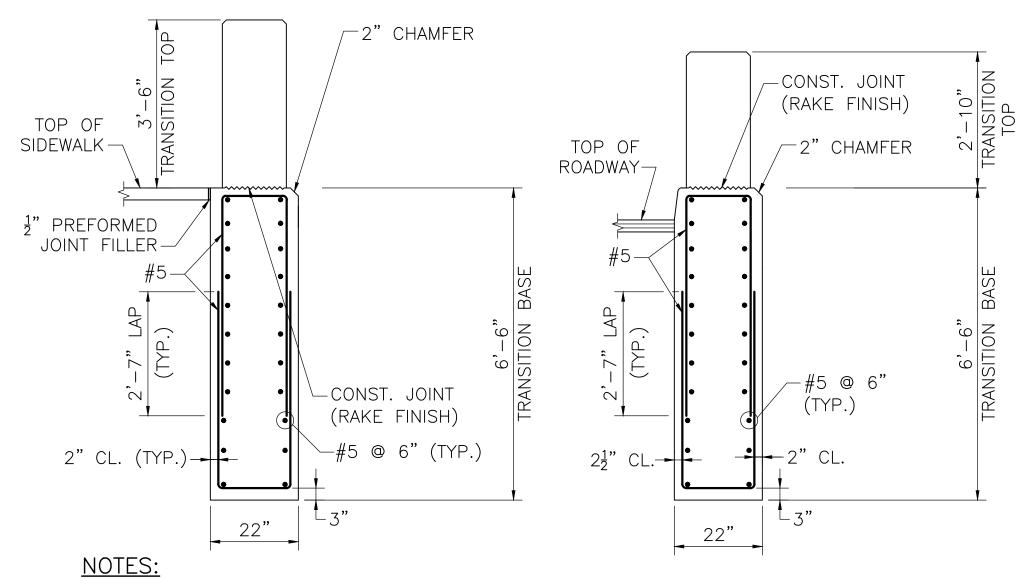


NOTES:

- 1. PRECAST GUARDRAIL TRANSITION SHALL BE 5000 PSI, ¾ IN, 685 HP CEMENT CONCRETE.
- 2. GRAVEL BORROW SHALL BE PLACED AND THOROUGHLY COMPACTED TO THE GRADE OF 3" (MIN.) BELOW THE INTENDED BOTTOM OF THE PRECAST GUARDRAIL TRANSITION BASE AND TO A HEIGHT OF 2'-0" (MIN.) ON ALL SIDES OF THE TRANSITION BASE TO FORM A TRENCH IN WHICH TO SET THE TRANSITION. WHERE NO GRAVEL BORROW IS REQUIRED BELOW THE BASE, IT SHALL BE PLACED ON UNDISTURBED SOIL
- 3. CONTRACTOR SHALL SET THE PRECAST GUARDRAIL TRANSITION TO THE REQUIRED ELEVATION AND ALIGNMENT, AND BACKILL PRECAST GUARDRAIL TRANSITION WITH CONTROLLED DENSITY FILL (NON-EXCAVATABLE) TO THE ELEVATION SHOWN.
- 4. THE REST OF REINFORCEMENT IS NOT SHOWN FOR CLARITY.

PRECAST GUARDRAIL TRANSITION ELEVATION

SCALE: $\frac{1}{2}$ " = 1'-0"

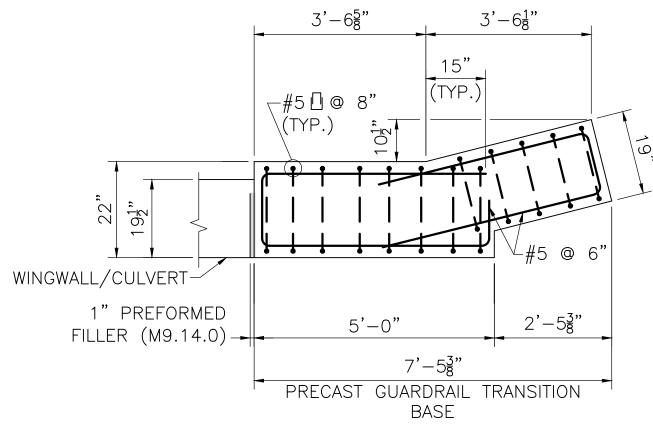


1. REINFORCEMENT OF THE TRANSITION TOP IS NOT SHOWN FOR CLARITY.

SECTION 1 AT SIDEWALK

SCALE: $\frac{1}{2}$ " = 1'-0"

SECTION 1 AT SAFETY CURB SCALE: $\frac{1}{2}$ " = 1'-0"



NOTE:
WINGWALL REINFORCEMENT AND STRIATIONS
NOT SHOWN FOR CLARITY.

<u>SECTION 2</u> SCALE: $\frac{1}{2}$ " = 1'-0"

COMMONWEALTH OF MASSACHUSETTS
MassDOT, Highway Division
CONCEPTUAL DESIGN IS ACCEPTABLE TO
MASSDOT FOR CONTRACTING
Mohammed Nabulsi
Mohammed Nabulsi (Oct 7, 2024 13:50 EDT)

DISTRICT 3 BRIDGE ENGINEER DATE

BRIDGE SHEET 11 OF 13 BRIDGE NO. M-22-022 (CPC)

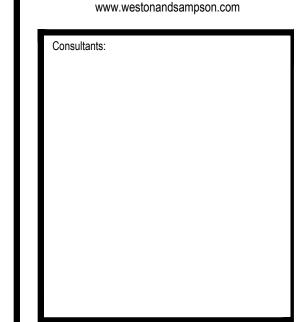
TOWN OF MILLBURY MILLBURY, MA

WHEELOCK AVENUE OVER DOROTHY POND

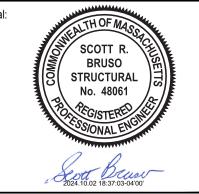
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CULVERT REPLACEMENT

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Reviewed By: CJW

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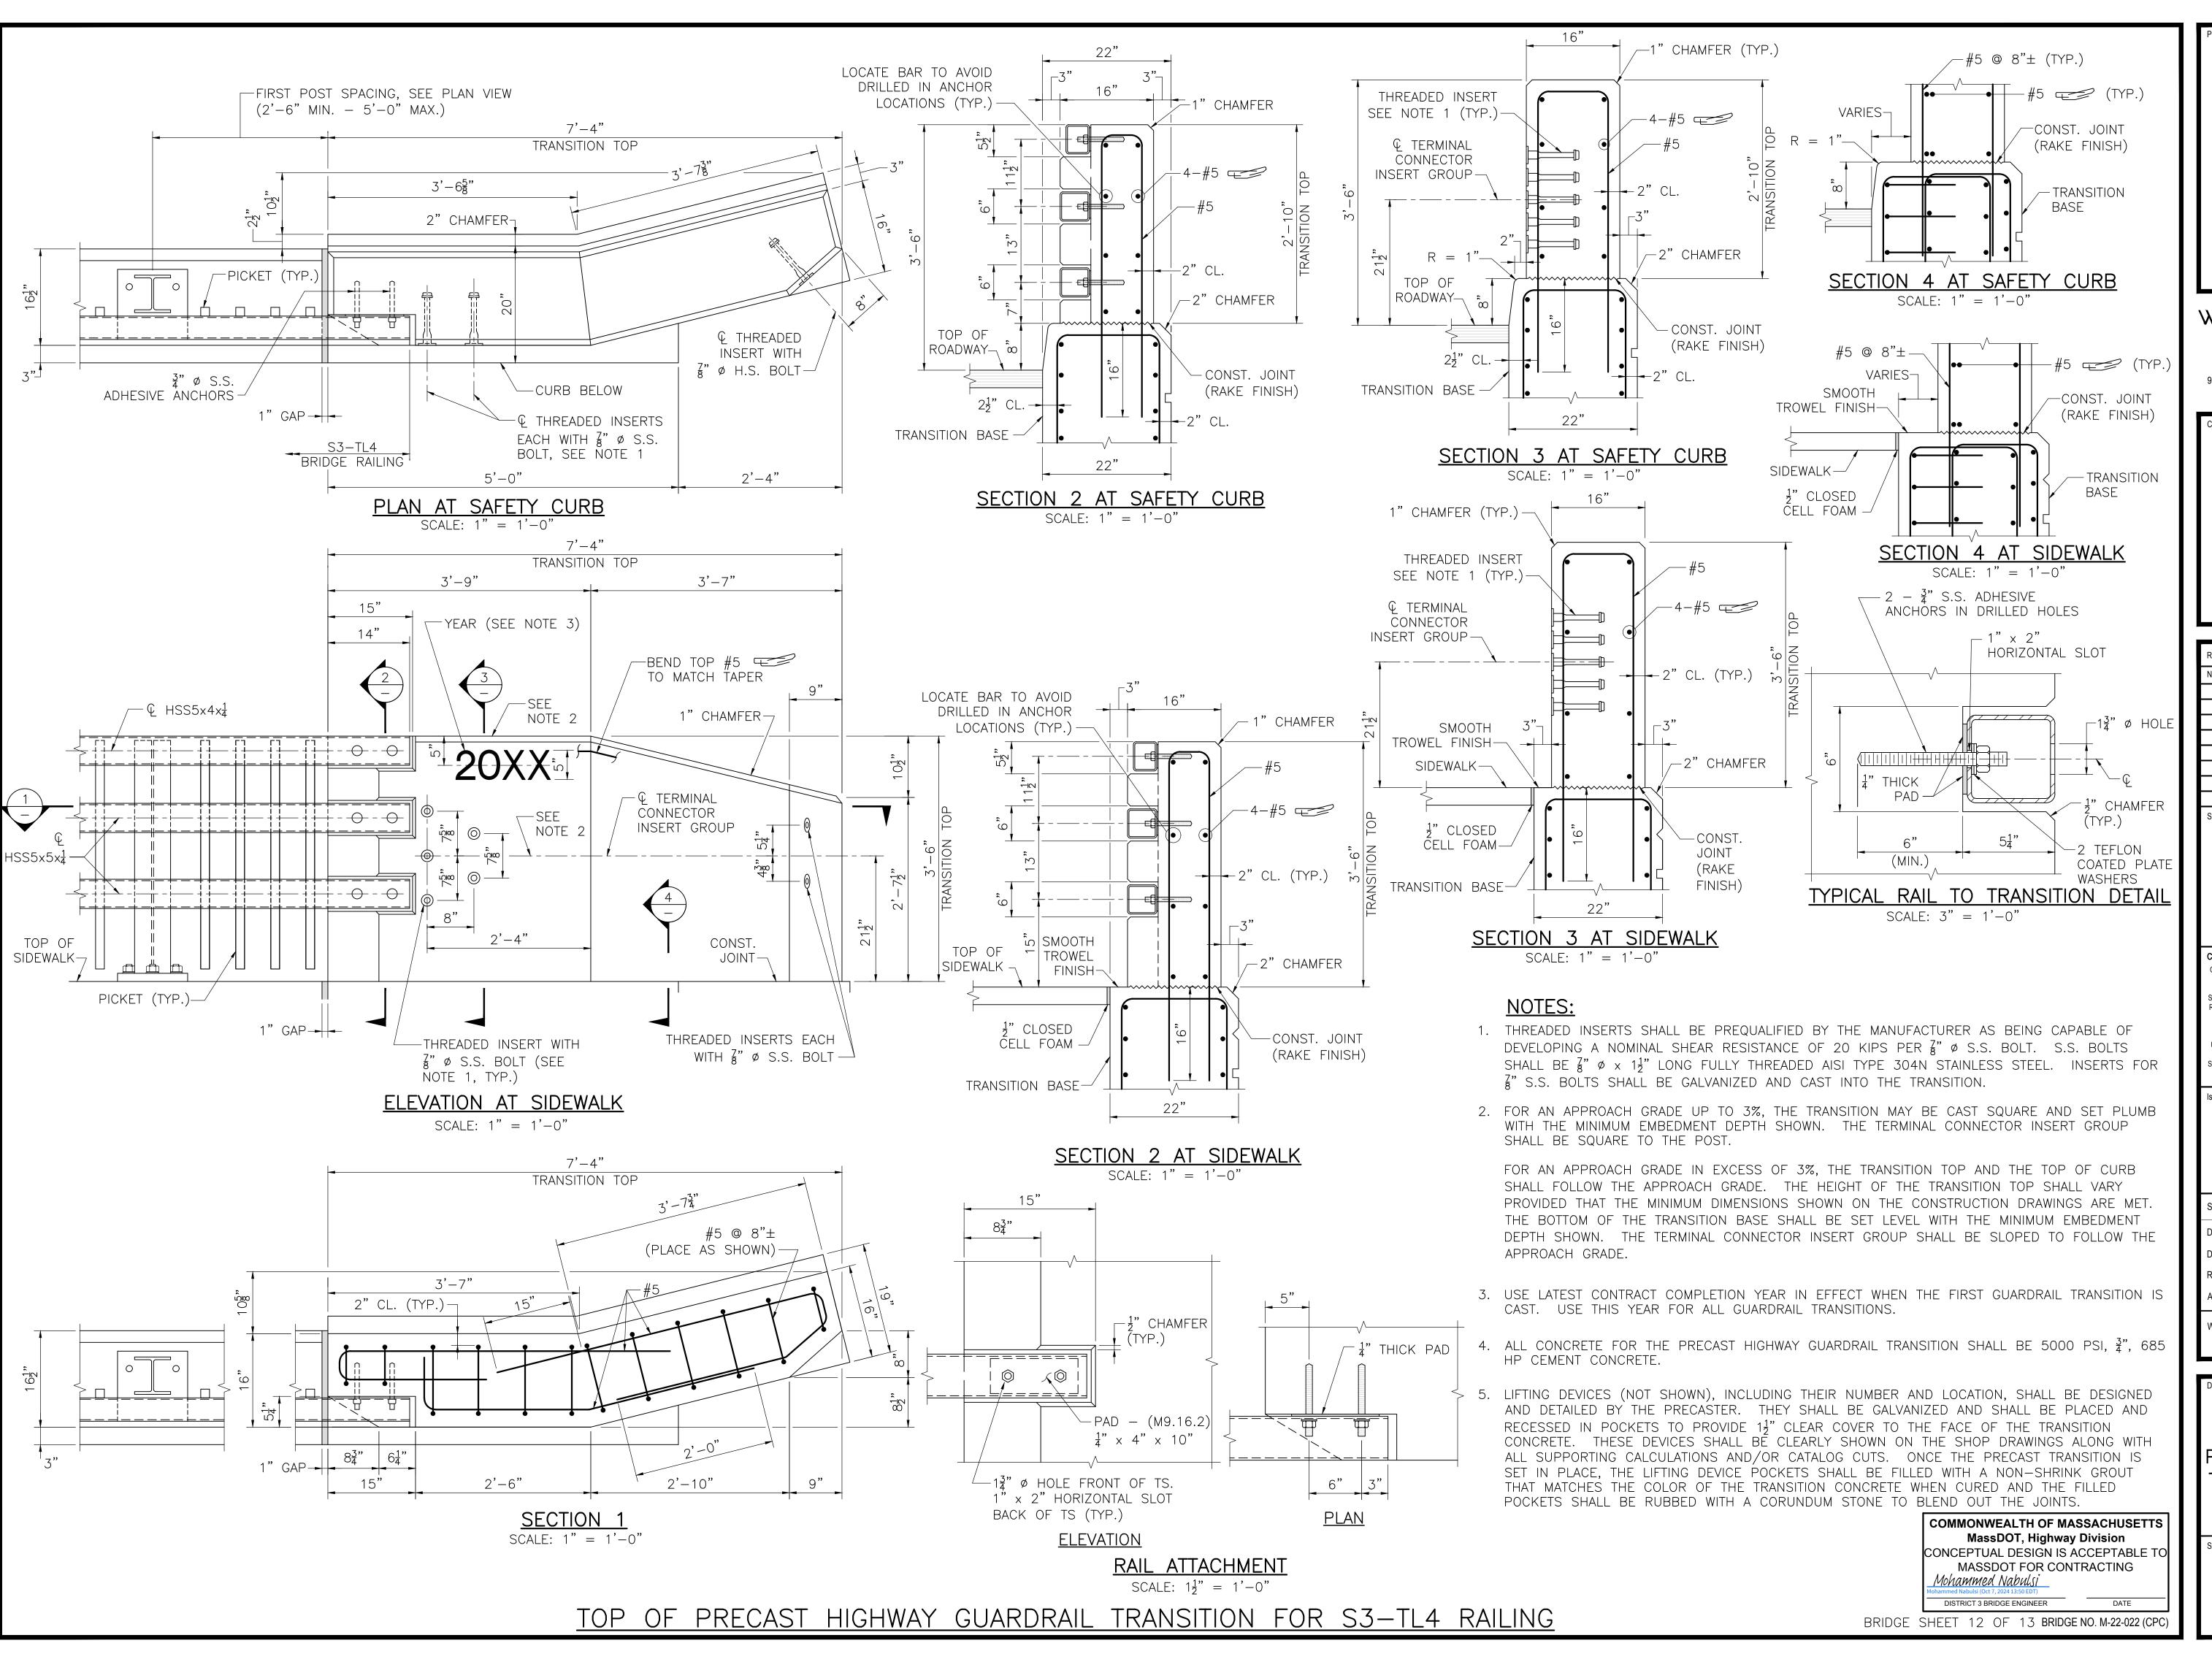
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Drawing Title:

PRECAST GUARDRAIL TRANSITION DETAILS

Sheet Number:

S-11



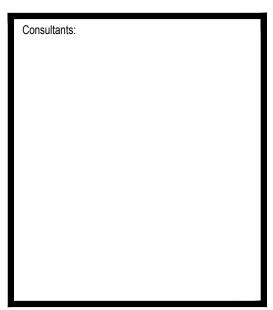
TOWN OF MILLBURY
MILLBURY, MA

WHEELOCK AVENUE OVER
DOROTHY POND

CULVERT REPLACEMENT

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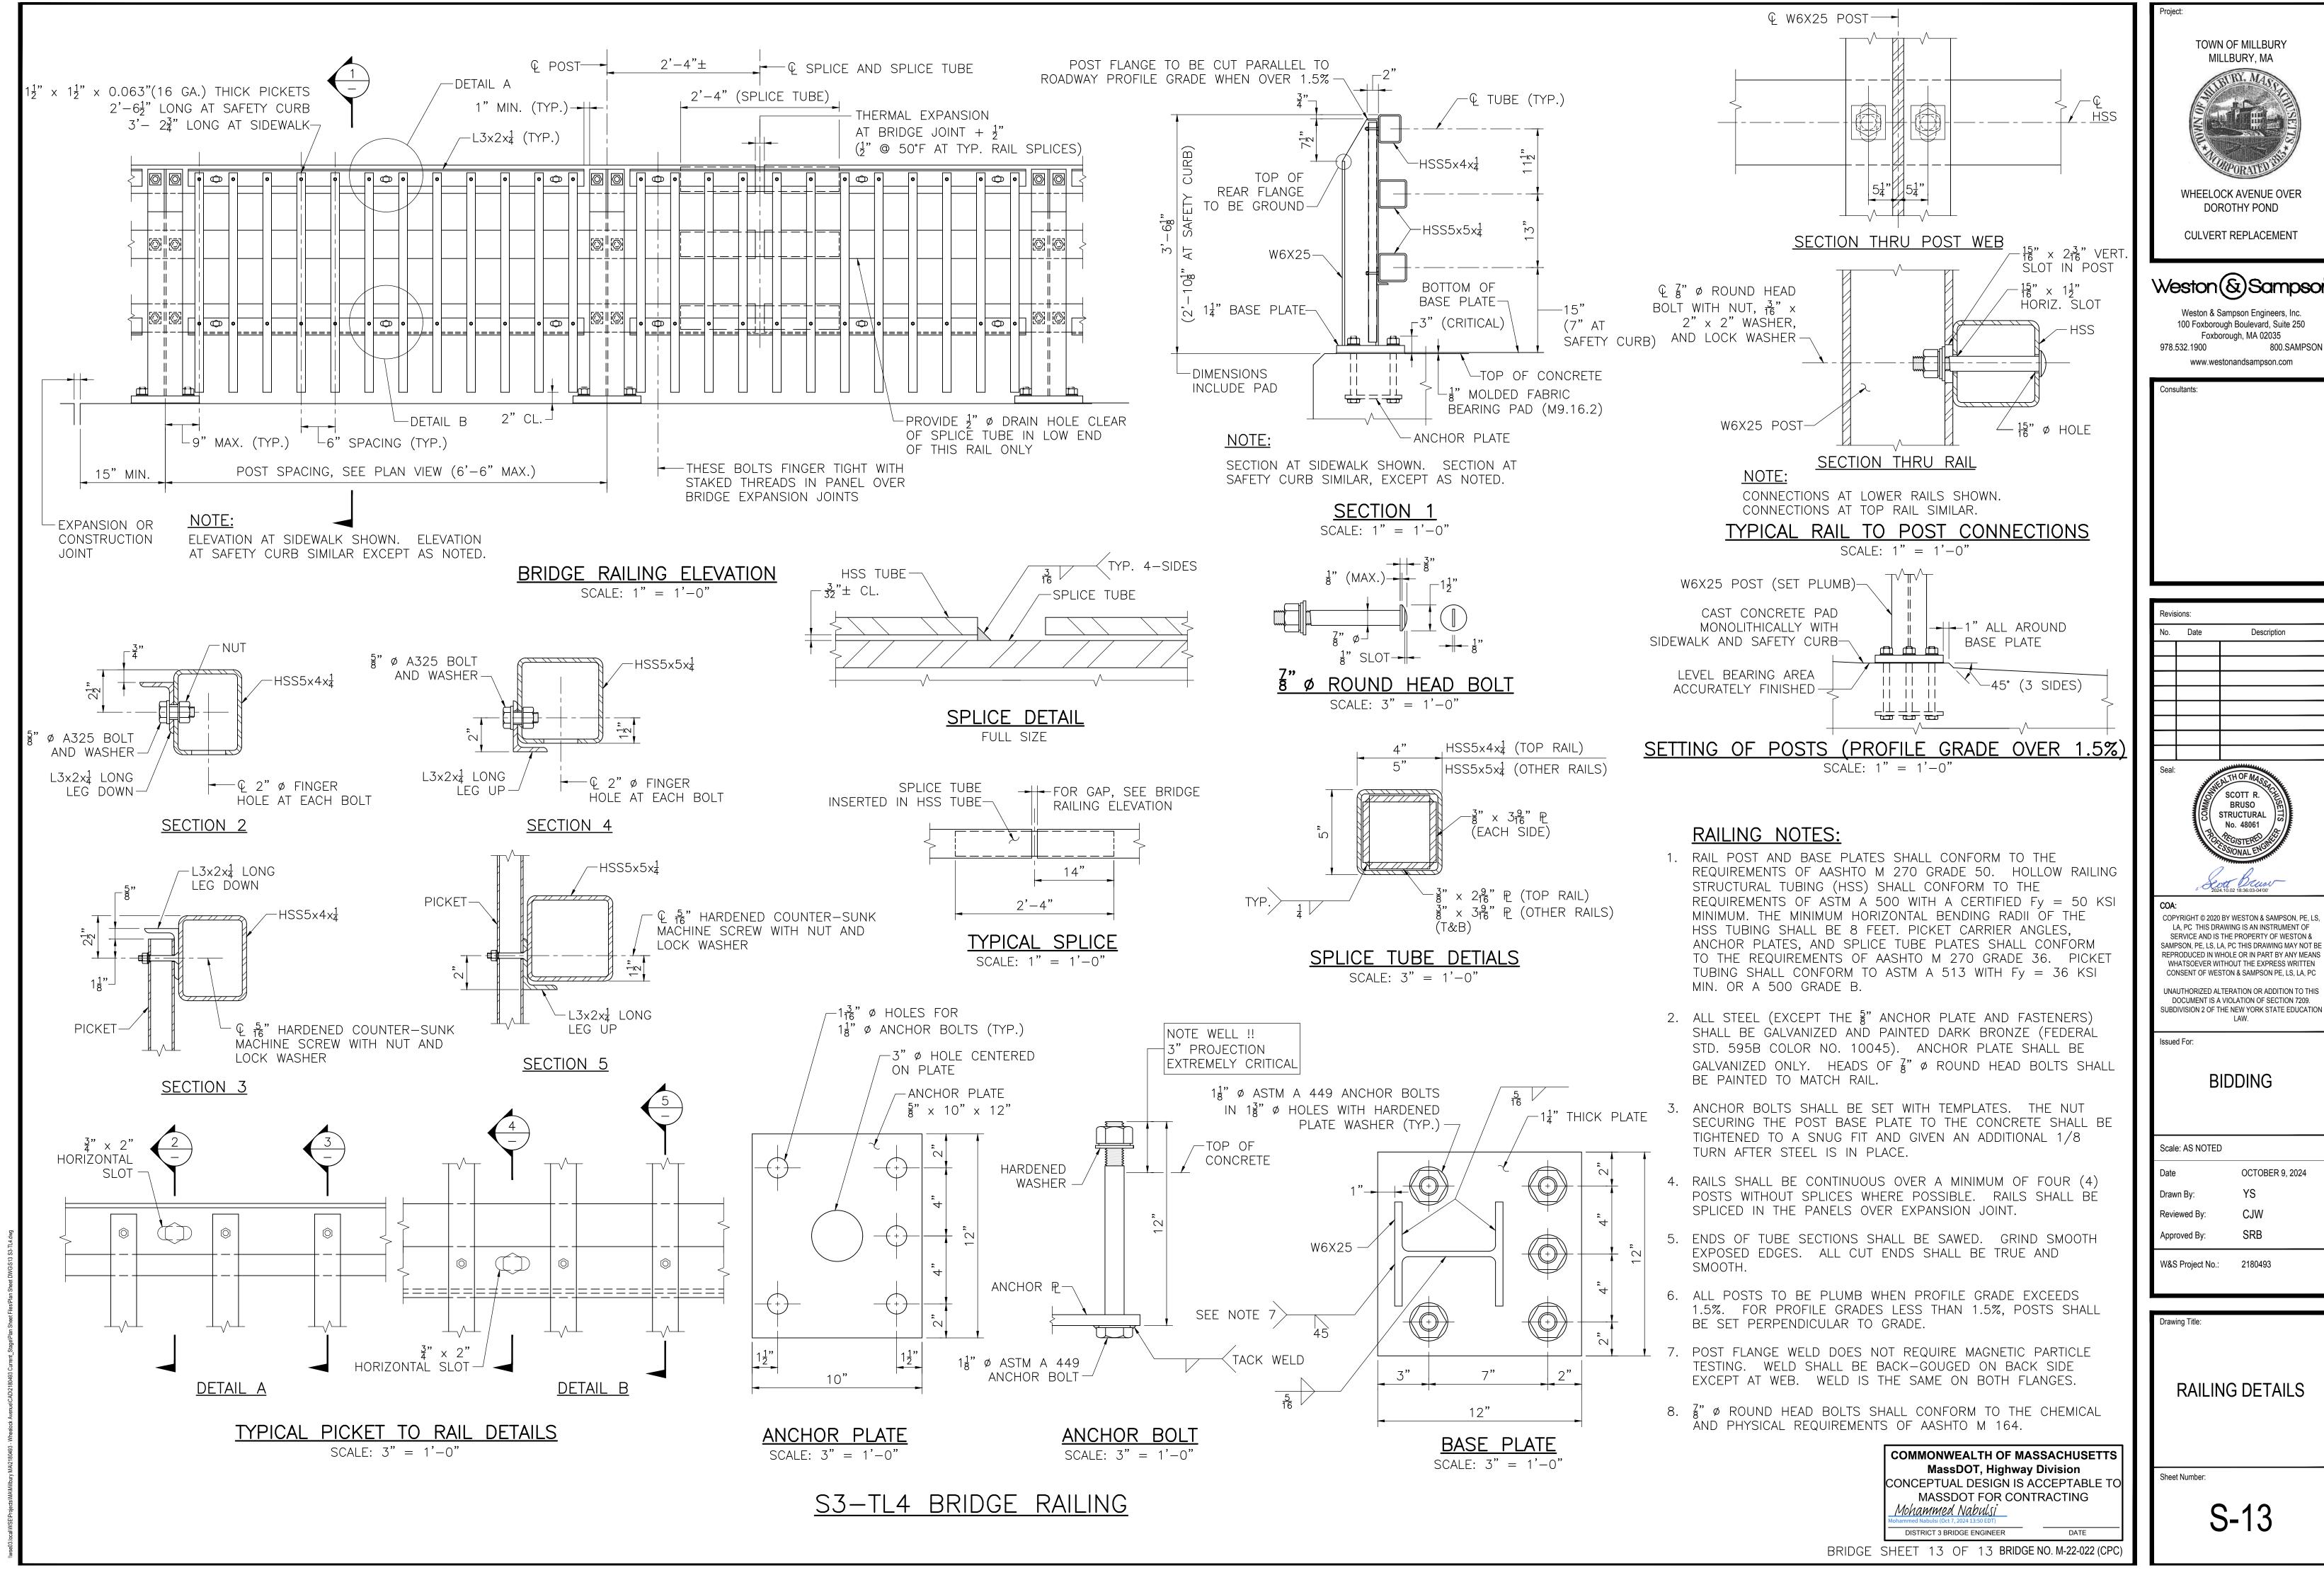
PRECAST GUARDRAIL

TRANSITION DETAILS

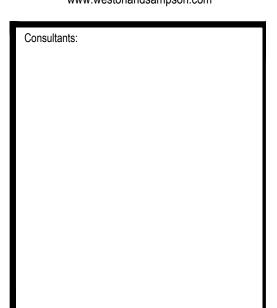
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